
SHEET INDEX	
I-1	INDEX SHEET
I-2	EXT. WINDOW AND DOOR SCHEDULE
A-1	SITE PLAN
A-2	BASEMENT PLAN
A-3	MAIN FLOOR PLAN
A-4	LOWER ROOF PLAN
A-5	3D & SECTION VIEWS
A-6	ELEVATION EAST & SOUTH
A-7	ELEVATION WEST & NORTH
F-1	MAIN FLOOR FRAMING
F-2	UPPER FLOOR FRAMING
M-1	MECHANICAL SHEET
P-1	PLUMBING DETAILS
P-2	RADIANT HEAT BASEMENT PLAN
P-3	RADIANT HEAT MAIN FLOOR PLAN
E-1	BASEMENT ELECTRICAL PLAN
E-2	MAIN FLOOR ELECTRICAL PLAN
SD-1	STRUCTURAL DETAILS
SD-2	STRUCTURAL DETAILS
SD-3	STRUCTURAL DETAILS

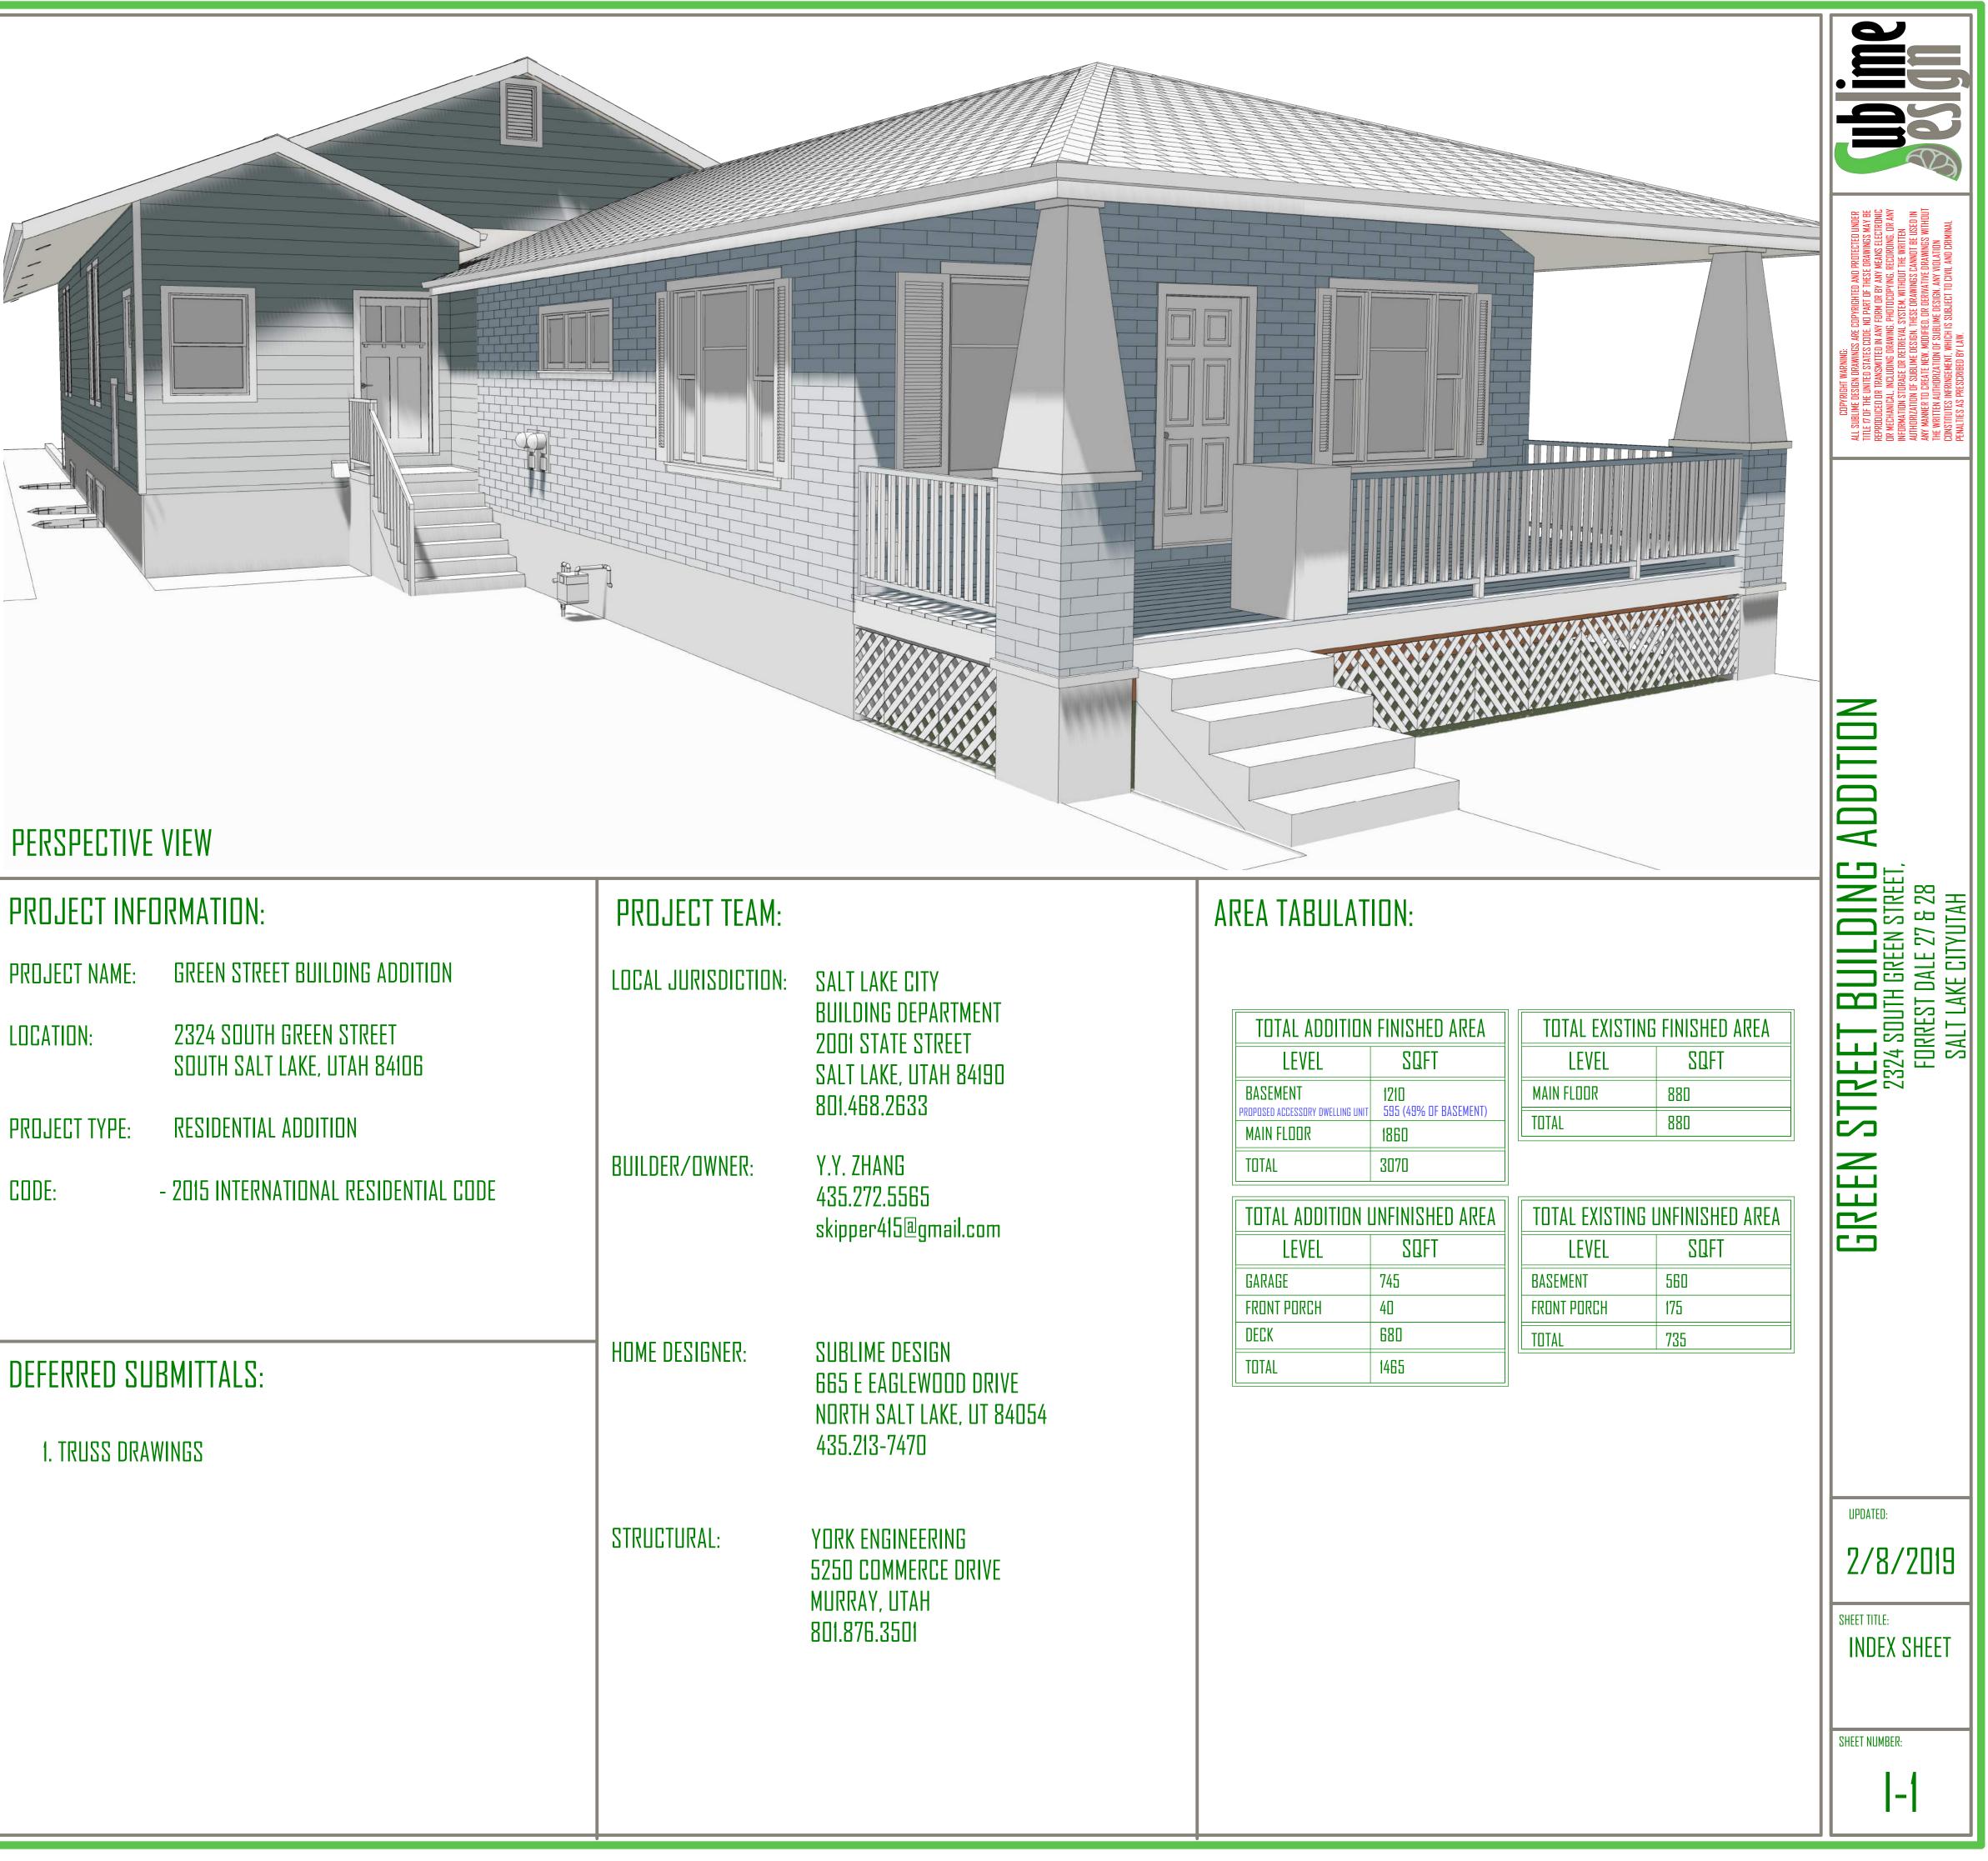

NOTES:

GENERAL:

1. CONTRACTOR SHALL VERIFY ALL CONDITIONS AND DIMENSIONS AT THE SITE AND ALL INCONSISTENCIES SHALL BE BROUGHT TO THE ATTENTION OF THE DEVELOPER AND THE ARCHITECT BEFORE PROCEEDING WITH WORK.

2. ANY ERRORS OR OMISSIONS FOUND IN THESE DRAWINGS SHALL BE BROUGHT TO THE DEVELOPERS AND ARCHITECTS ATTENTION IMMEDIATELY

3. DO NOT SCALE DRAWINGS. WRITTEN DIMENSIONS TAKE PRECEDENCE OVER SCALED DIMENSIONS. 4. ALL DIMENSIONS ARE TO FACE OF STUD FRAMING UNLESS OTHERWISE NOTED.

5. ALL (OR EQUAL) SUBSTITUTIONS MUST BE SUBMITTED TO AND APPROVED BY CITY BUILDING OFFICIALS PRIOR TO INSTALLATION.

ADU STANDARDS: ALL STANDARDS FOR AN ACCESSORY DWELLING UNIT FOUND IN SECTION 21A.40.200.E. OF THE SALT LAKE CITY CODE SHALL BE ADHERED AND FOLLOWED.

THE FOLLOWING STANDARDS ARE APPLICABLE TO THE PROPOSED ADU:

2. DESIGN REQUIREMENTS

a. Compatibility: An accessory dwelling unit shall be designed and constructed to be compatible with the principal dwelling.

b. Underlying Zoning Applies: Unless specifically provided in this section, an accessory dwelling unit shall conform to the lot and bulk requirements of the underlying zoning district, including building and wall height, setbacks, yard requirements, and building coverage.

c. Area of Accessory Dwelling Unit: (1) The maximum gross floor area of an attached accessory dwelling unit may not exceed fifty percent (50%) of the gross floor area of the principal dwelling.

e. Location of Entrance to Accessory Dwelling Unit:

(1) Internal or Attached Units: Accessory dwelling units that are internal or attached to a principal dwelling may be accessible from the following:

(a) An existing entrance to the principal dwelling.

(b) An additional entrance on a street-facing facade provided


h. Parking:

(1) An accessory dwelling unit requires one on-site parking space.


١FD	RMATION:	PROJECT TEAM:	
E:	GREEN STREET BUILDING ADDITION 2324 South Green Street South Salt Lake, Utah 84106	LOCAL JURISDICTION:	SALT LAKE CITY BUILDING DEPARTMENT 2001 STATE STREET
	RESIDENTIAL ADDITION		SALT LAKE, UTAH 84190 801.468.2633
	2015 INTERNATIONAL RESIDENTIAL CODE	BUILDER/OWNER:	Y.Y. ZHANG 435.272.5565 skipper415@gmail.com
	SMITTALS:	HOME DESIGNER:	SUBLIME DESIGN 665 E EAGLEWOOD DRIVE NORTH SALT LAKE, UT 84054 435.213-7470
		STRUCTURAL:	YORK ENGINEERING 5250 COMMERCE DRIVE MURRAY, UTAH 801.876.3501

WINDOW SCHEDULE

				BASEMENT V						
#	3D	QTY	SIZE	DESCRIPTION	BOTTOM	TOP	EGRESS	TEMP.	COMMENTS	
WD1		1	5050RS	RIGHT SLIDING	20"	80"				
W02		3	5050LS	LEFT SLIDING	20"	80"				
WO3		2	5050LS	LEFT SLIDING	20"	80"	YES		NET CLEAR OPENING: 27.187 W X 56.312 H (AREA=10.632)	

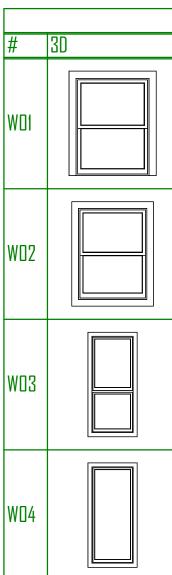

WINDOW FLASHING DETAIL

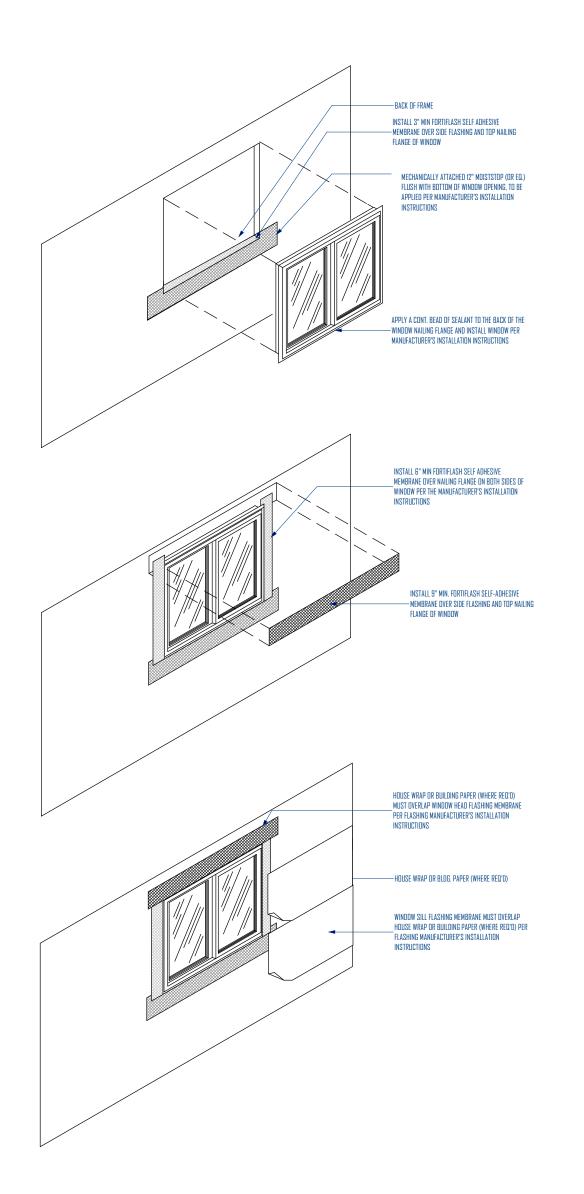


EXTERIOR DOOR SCHEDULE

								_
		_		<u>CHEDULE</u>	<u>WINDOW S</u>	MAIN FLOOR		
NUMB	COMMENTS	TEMP.	EGRESS	TOP	BOTTOM	DESCRIPTION	SIZE	ΤY
DD1		YES		48"	0"	SINGLE HUNG	3040SH	1
D02		YES		92"	44"	SINGLE HUNG	3040SH	2
D03	3040FX, 3030SC NET CLEAR OPENING: 28.77 X 30.874 (AREA=6.17)		YES	108"	24"	MULLED UNIT	3070	4
NUMB				108"	24"	FIXED GLASS	3070FX	4

			BASEMENT E	XTERIOR DOOR SCI	HEDULE
NUMBER	3D PERSPECTIVE	QTY	SIZE	STYLE	COMMENTS
DDI		3	9080	GARAGE DOOR CHDO5	
D02		1	3068 L EX	DOOR PO3	
D03		1	3068 R EX	DOOR PO3	
			MAIN FLOOR	EXTERIOR DOOR SC	HEDULE
NUMBER	3D PERSPECTIVE	QTY	SIZE	STYLE	COMMENTS
DOI		1	3068 R EX	DOOR E21	

EXTERIOR DOOR FLASHING DETAIL

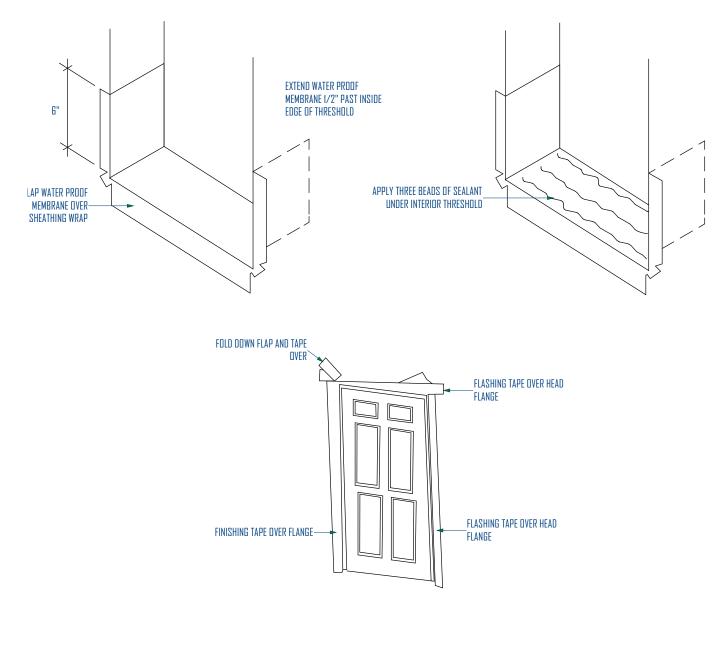

NOTES:

TEMPERED WINDOW CODES:

R308.4.3 Glazing in Windows

Glazing in an individual fixed or operable panel that meets all of the following conditions shall be considered to be a hazardous location: 1. The exposed area of an individual pane is larger than 9 square feet (0.836 m2),

2. The bottom edge of the glazing is less than 18 inches (457 mm) above the floor,

3. The top edge of the glazing is more than 36 inches (914 mm) above the floor; and

4. One or more walking surfaces are within 36 inches (914 mm), measured horizontally and in a straight line, of the glazing.

Exceptions: 1. Decorative glazing.

2. Where a horizontal rail is installed on the accessible side(s) of the glazing 34 to 38 inches (864 to 965 mm) above the walking surface. The rail shall be capable of withstanding a horizontal load of 50 pounds per linear foot (730 N/m) without contacting the glass and have a crosssectional height of not less than 11/2 inches (38 mm).

3. Outboard panes in insulating glass units and other multiple glazed panels where the bottom edge of the glass is 25 feet (7620 mm) or more above grade, a roof, walking surfaces or other horizontal (within 45 degrees (0.79 rad) of horizontal) surface adjacent to the glass exterior.

R308.4.5 Glazing and Wet Surfaces

Glazing in walls, enclosures or fences containing or facing hot tubs, spas, whirlpools, saunas, steam rooms, bathtubs, showers and indoor or outdoor swimming pools where the bottom exposed edge of the glazing is less than 60 inches (1524 mm) measured vertically above any standing or walking surface shall be considered to be a hazardous location. This shall apply to single glazing and each pane in multiple glazing. Exception: Glazing that is more than 60 inches (1524 mm), measured horizontally and in a straight line, from the water's edge of a bathtub,

hot tub, spa, whirlpool or swimming pool or from the edge of a shower, sauna or steam room.

R308.4.7 Glazing Adjacent to the Bottom Stair Landing

Glazing adjacent to the landing at the bottom of a stairway where the glazing is less than 36 inches (914 mm) above the landing and within a 60-inch (1524 mm) horizontal arc less than 180 degrees from the bottom tread nosing shall be considered to be a hazardous location.

Exception: The glazing is protected by a guard complying with Section R312 and the plane of the glass is more than 18 inches (457 mm) from the guard.

EGRESS WINDOW CODES

R310.2.1 Minimum Opening Area

Emergency and escape rescue openings shall have a net clear opening of not less than 5.7 square feet (0.530 m2). The net clear opening dimensions required by this section shall be obtained by the normal operation of the emergency escape and rescue opening from the inside. The net clear height opening shall be not less than 24 inches (610 mm) and the net clear width shall be not less than 20 inches (508 mm).

Exception: Grade floor or below grade openings shall have a net clear opening of not less than 5 square feet (0.465 m2).

R310.2.2 Window Sill Height


Where a window is provided as the emergency escape and rescue opening, it shall have a sill height of not more than 44 inches (118 mm) above the floor; where the sill height is below grade, it shall be provide with a window well in accordance with Section R310.2.3.

R310.2.3 Window Wells

The horizontal area of the window well shall be not less than 9 square feet (0.9 m2), with a horizontal projection and width of not less than 36 inches (914 mm). The area of the window well shall allow the emergency escape and rescue opening to be fully opened. Exception: The ladder or steps required by Section R310.2.3.1 shall be

permitted to encroach not more than 6 inches (152 mm) into the required dimensions of the window well.



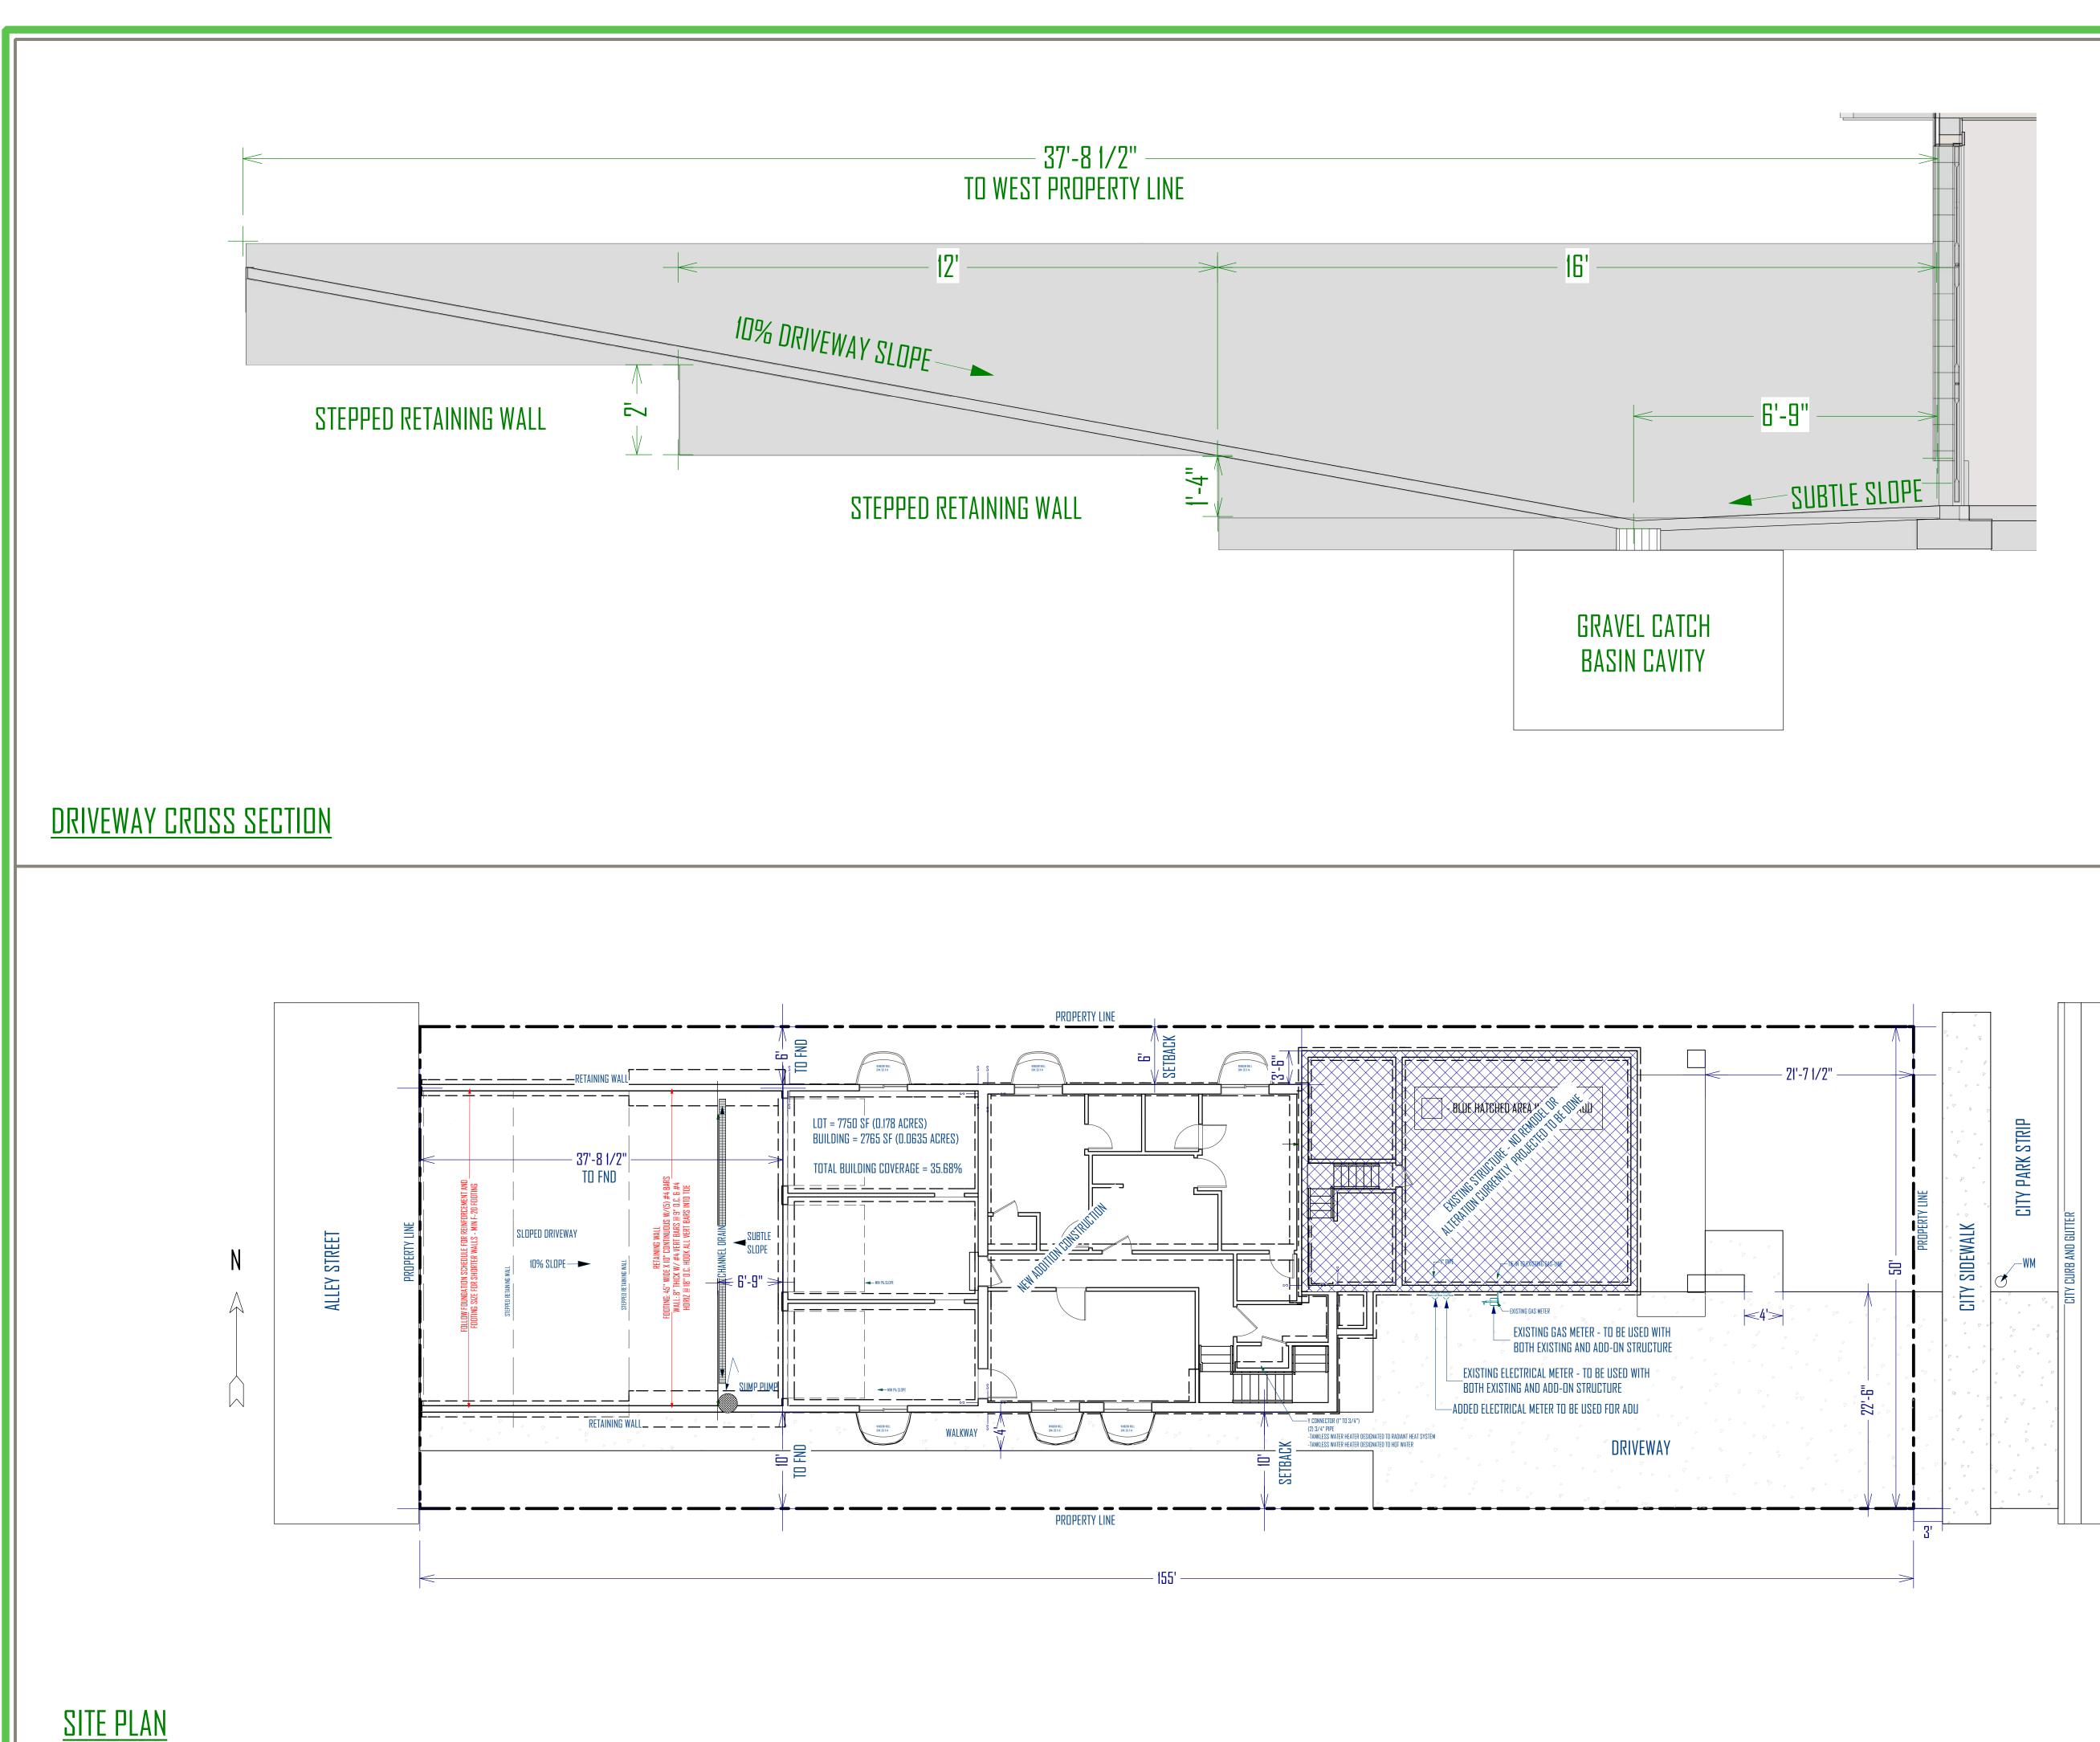

SCALE: 1/8"=1'-0"

NOTES:

SITE SPECIFIC NOTES:

DRAINS SHALL BE PROVIDED AROUND ALL CONCRETE OR MASONRY FOUNDATIONS THAT RETAIN EARTH AND ENCLOSE HABITABLE OR USABLE SPACES LOCATED BELOW GRADE. DRAINAGE TILES, GRAVEL OR CRUSHED STONE DRAINS, PERFORATED PIPE OR OTHER APPROVED SYSTEMS OR MATERIALS SHALL BE INSTALLED AT OR BELOW THE AREA TO BE PROTECTED AND SHALL DISCHARGE BY GRAVITY OR MECHANICAL MEANS INTO AN APPROVED DRAINAGE SYSTEM.

EROSION CONTROL NOTES:

1) A STABILIZED GRAVEL CONSTRUCTION ENTRANCE SHALL BE INSTALLED AS FIRST SITE ACTIVITY

2) EROSION CONTROL MEASURES SHALL BE INSPECTED DAILY AND MAINTAINED AS NECESSARY TO ENSURE THEIR FUNCTION 3) EROSION CONTROL MEASURES SHALL BE KEPT IN PLACE UNTIL PERMANENT GROUND COVER IS ESTABLISHED

GENERAL GRADING NOTES:

ALL STORM WATER AND DIRT WILL BE KEPT ON SITE DURING CONSTRUCTION UNTIL FINAL LANDSCAPING IS DONE.

THE GRADE ADJACENT TO ALL FOUNDATION WALLS SHALL FALL A MINIMUM OF 6 INCHES WITHIN THE FIRST 10 FEET (5%).

STREET, CURB AND GUTTER WILL BE INSPECTED AND CLEANED OF ALL MUD AND DIRT AT THE END OF EVERY DAY.

GRAVEL BAGS TO BE PLACED AND MAINTAINED AROUND ANY STORM DRAIN INLET ADJACENT TO OR IMMEDIATELY DOWNSTREAM FROM SITE DURING CONSTRUCTION.

BERMS OR SWALES MAY BE REQUIRED ALONG PROPERTY LINES TO PREVENT STORM WATER FLOW ONTO ADJACENT LOTS. FINAL GRADING SHALL BLEND WITH ADJACENT LOTS.

A LINED CONCRETE WASHOUT AREA MUST BE PROVIDED AT THE SITE FOR ALL CONCRETE WORK. WASHOUT INTO THE FOUNDATION OR ON THE GROUND IS PROHIBITED.

ALL PROPERTY CORNERS SHALL BE IDENTIFIED WITH HUBS AND REFERENCE STAKES. IF ANY OF THE ABOVE POINTS ARE MISSING OR HAVE NOT BEEN DONE, THEY SHALL BE ESTABLISHED BY A REGISTERED SURVEYOR PRIOR TO THE LAYOUT/SETBACK & FOOTING INSPECTION. NO FOOTING SHALL BE DONE UNTIL THIS INSPECTION HAS BEEN ACCOMPLISHED.

ALL LOT GRADING SHALL BE SUCH THAT STORM WATER RUNDFF SHALL BE RETAINED ON-SITE WITHIN LOT BOUNDARIES. RETENTION BASIN SHALL REMAIN A PERMANENT FEATURE.

IN OTHER THAN GROUP I SOILS, A SUMP SHALL BE PROVIDED TO DRAIN THE POROUS LAYER AND FOOTINGS. THE SUMP SHALL BE AT LEAST 24 INCHES IN DIAMETER OR 20 INCHES SQUARE, EXTEND AT LEAST 24 INCHES BELOW THE BOTTOM OF THE BASEMENT FLOOR AND SHALL BE CAPABLE OF POSITIVE GRAVITY OR MECHANICAL DRAINAGE TO REMOVE ANY ACCUMULATED WATER. THE DRAINAGE SYSTEM SHALL DISCHARGE INTO AN APPROVED STORM SEWER SYSTEM OR TO DAYLIGHT.


STREET

GREEN




Julio
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GREEN STREET BUILDING ADDITION 2324 South Green Street, Forrest dale 27 & 28 Salt lake cityutah
updated: 2/8/2019 Sheet title: SITE PLAN
SHEET NUMBER:

SCHEI	DULE:																				
	BASMENT PLUMBING FIXTURE				FOOT	ING SCH	EDULE									SH	EAR W	ALL SCHEDUI	LE		
NUMBER	QTY DESCRIPTION	COMMENTS	ТҮРЕ	WIDTH	LENGTH	I THI	CK	REINFD	RCEMEN	IT		T	YPE	SH	EATHIN		NAIL	EDGE	FIELD	STAPLE ED]
P01	2 CHAMFER CORNER SHOWER K-2293-8 WELLWORTH PEDESTAL		F-16	16"	CONT.	10		2: # 4 E					PICAL		" ONE SI		8D	6" O.C.	12" O.C.	16 G @ 3" O	
PO2	2 BATHROOM SINK		F-18	18"	CONT.	10		2:#4E					W-1		" ONE SI		8D	4" D.C.	12" D.C.	16 G @ 3" O	
PO3	1 SINK (SQUARE) [20]		F-20 F-24	20" 24"	CONT. CONT.	10 10		2: #4E 3: #4E					W-2		" ONE SI		8D	3" O.C.	12" O.C.		
P04	2 TOILET (STANDARD)		F-30	30"	CONT.			3: # 4 [
P05	2 WASHER		F-36	36"	CONT.	10		4: # 4 E					W-3		" ONE SI		8D		12" D.C.	NOT ALLOW	EU
P06	1 DRYER VENT		S-24	24"	24"	10		3: # 4 BA	RS EACH	I WAY							if 208	911101FD FD	R 8D NAILS A	AT 17 Z ^m	
	BASMENT INTERIOR DOOR SCHED	DULE	S-30	30"	30"	10		3: # 4 BA							ICAL AN						
NUMBER	TYPE QTY SIZE	COMMENTS	S-36	36"	36"	10		4: # 4 BA				SW	<u>-2 ANE</u>	<u>) SM-3</u>	REQUIR	E 3X DI	<u>२ (2) C</u>	N JOINING P	ANEL EDGES		
DDI	HINGED 4 3068 L IN		S-42 S-48	42" 7.8"	42" 48"	12		5: # 4 BA 6: # 4 BA													
D02	HINGED 2 2668 R IN		S-40 S-60	40 60"	40 60"	12		7: # 4 BA													
D03	HINGED 4 2668 L IN		0.00			12	•	1. 11 1 11													
D04	HINGED 1 3068 R IN		3,000 P	PSI CONCRETE					FN	UNDATIC	IN SE	HFDIII	F						60),000 PSI STEEL	
	BASMENT APPLIANCE SCHEDUI		· ·				VER	RTICAL WALL		RIZONTAL			L Al Reinf. FC	R			A	DDITIONAL FTG.			
NUMBER	QTY DESCRIPTION	COMMENTS	MAXIMUM W/ HEIGHT FRO		OP EDGE UPPORT	MIN. WALL		REINF.	<u> </u>	ILL REINF.			ENINGS		MAX. – LINTEL	MIN. LINTEL	5	IZE AND REINF.	NOTES		FOUNDATION BOLTS MIN. 7" EMBEDMENT)
AD1 AD2	1 BETRODD BOTTOM FREEZER 1 DISHWASHER		T.O. FOOTIN	NG		WIDTH	SIZE	SPACING	SIZE	SPACING	ABC ND.	SIZE NO.	SIDES SIZE	BELOW NO. SIZE	LENGTH	DEPTH	WIDTH	LENGTH		()	MIN. / EMDEDMENT/
AUZ	2 DRYER		2'-0" TO 5'-1	.0"	NDNE	8"	#4	24" O.C.	#4	18" O.C.	2	#4 1	#4	1 #4	2'	6"	5	EE FTG. SCHED.			12" X 10" @ 32" O.C.
A04	1 GAS METER		5'-1" TO 6'-C	0"	NDNE	8"	#4	18" O.C.	#4	18" O.C.	2	#4 1	#4	1 #4	3'	6"	36"	4 #4 X CONT	SEE NOTE 8 B	IELOW	12" X 10" @ 32" O.C.
A05	2 ELECTRICAL METER		6'-1" TO 7'-C	0"	NDNE	8"	#4	12" O.C.	#4	18" O.C.	2	#4 1	#4	1 #4	4'	8"	42"	5 #4 X CONT	SEE NOTE 8 B	IELOW	12" X 10" 🖲 32" O.C.
AD6	1 DRYER VENT		7'-10" TO 8'-		FLOOR	8"	#4	24" D.C.	#4	18" O.C.	2	#4 1	#4	1 #4	5'	10"		EE FTG. SCHED.			12" X 10" @ 32' O.C.
	BASMENT MECH. SCHEDULE	·	8'-1" TO 9'-C		FLOOR	8"	#4	16" O.C.	#4	18" O.C.	2	#4 1	#4	1 #4	6'	12"		EE FTG. SCHED.			12" X 10" @ 32" O.C.
NUMBER	QTY DESCRIPTION	COMMENTS	9'-1" TO 10'-1		FLOOR	8"	#4	12" O.C.	#4	12" O.C.	2	#4 1	#4	1 #4	6'	12"	24"	2 #4 X CONT	USE MIN F-24 F		58" X 10" @ 24" O.C.
MONULIN	2 WATER HEATER (TANKLESS)		10'-1" TO 11'-1		FLOOR	8"	#4	8" O.C.	#4	12" O.C.	2	#4 1	#4	1 #4	6'	12"	24"	2 #4 X CONT	USE MIN F-24 F	OOTING	58" X 10" @ 24" O.C.
			> '-[]"+	R	EQ. ENG.	-	-	-	-	-	-		-		-	-	-	-			REQ. ENG.

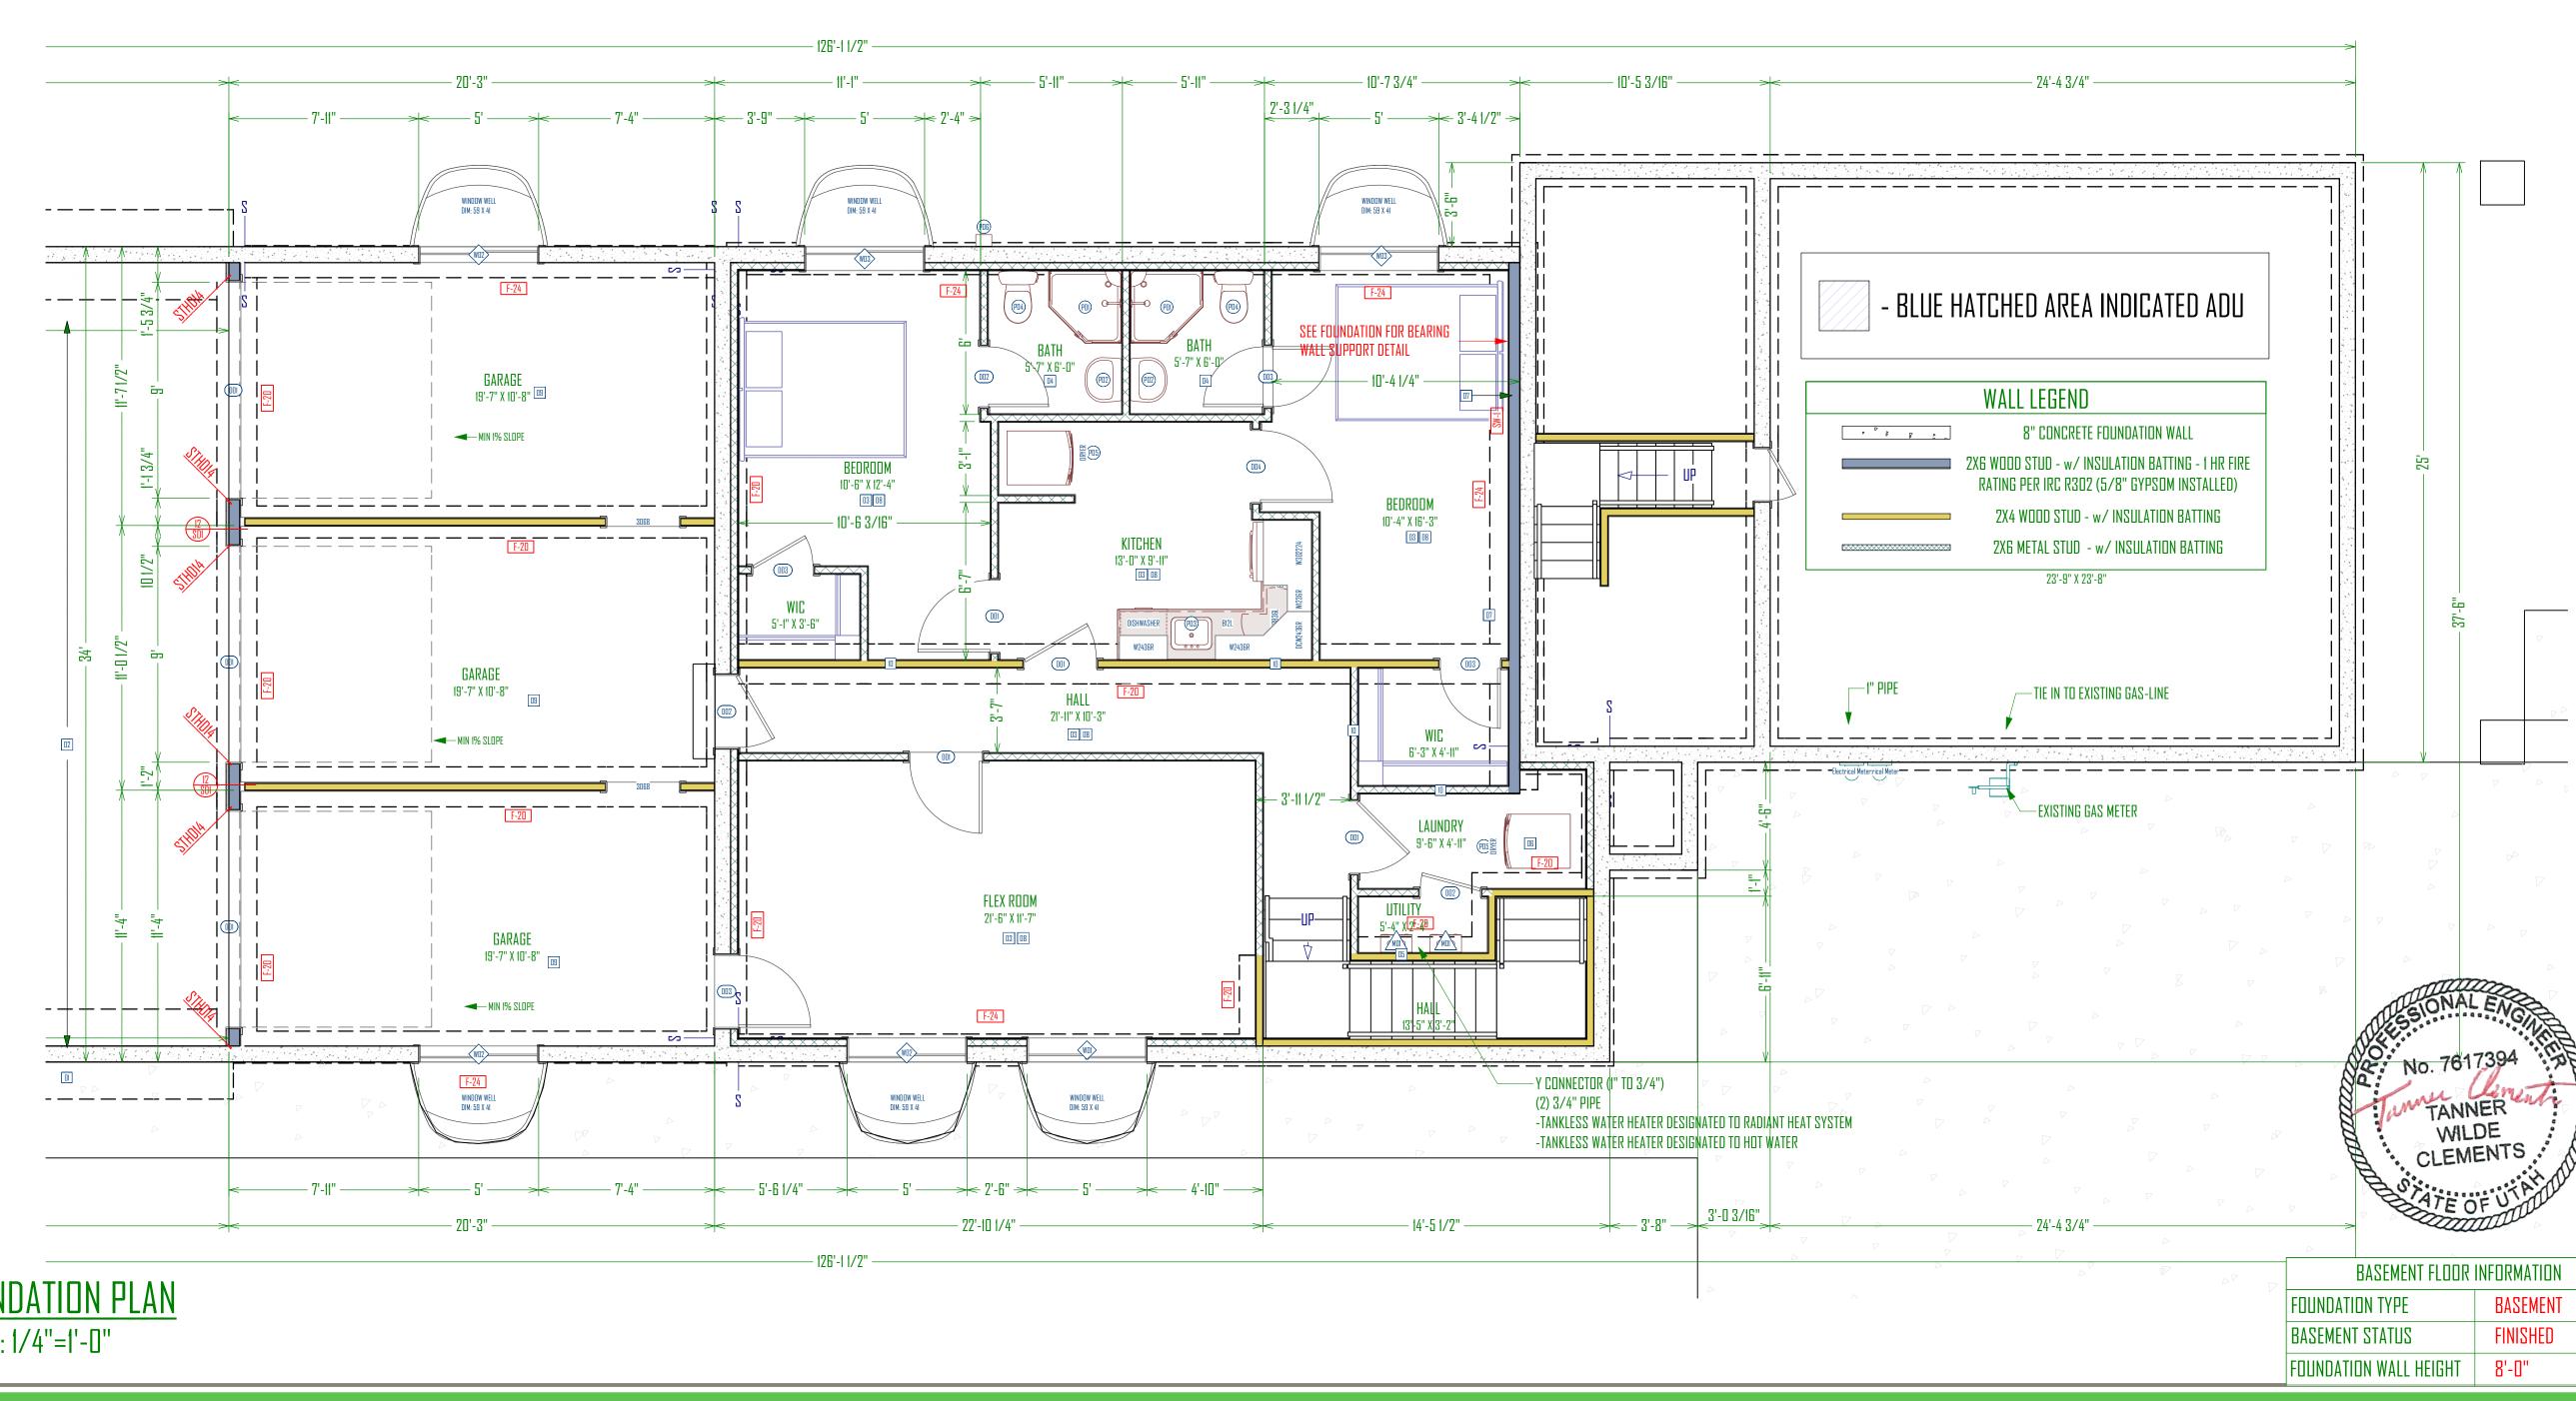

FOUNDATION PLAN SCALE: 1/4"=1'-0"

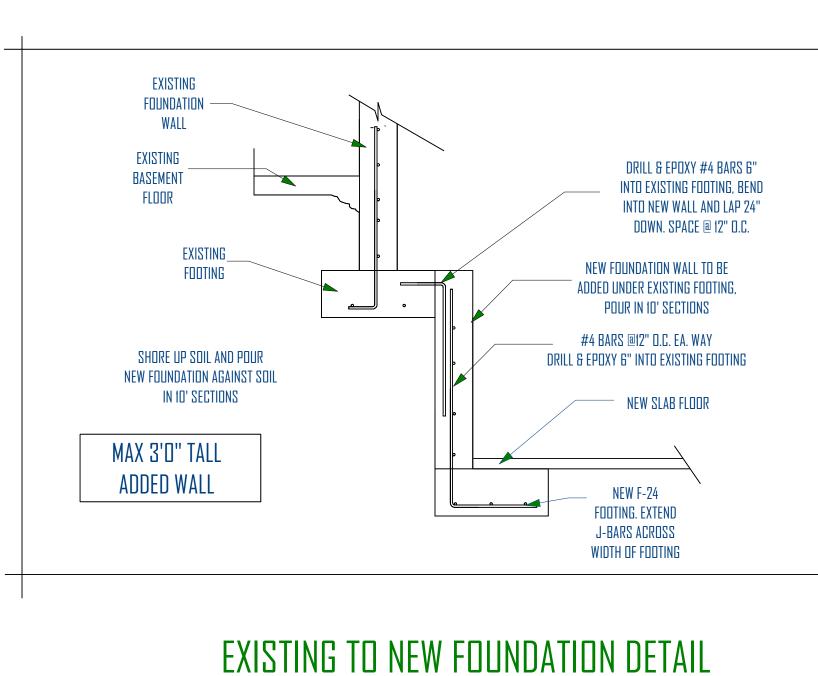

NOTES:

CONCRETE NOTES

1. FOOTINGS ARE TO BE CENTERED UNDER WALLS AND COLUMNS UNLESS NOTES OTHERWISE.

2.FOOTINGS AND FOUNDATIONS ARE TO BE PLACED ON NATIVE

UNDISTURBED SOILS OR COMPACTED TO FILL. 3.EXTERNAL FOOTINGS ARE TO BE PLACED 30" MIN. BELOW FINAL FINISHED GRADE FOR FROST PROTECTION.

4. REMOVE UNSATISFACTORY MATERIALS FROM EXCAVATION,

UNSATISFACTORY MATERIALS MAY INCLUDE BUT ARE NOT LIMITED TO:

VEGETATION, SOFT SPOTS, FOREIGN MATERIALS, EXISTING STRUCTURES, SLABS, ASPHALT, CONCRETE, ETC. 5. PROVIDE FOUNDATION BLOCKOUTS AS NEEDED FOR UTILITY ACCESS AND

GARAGE DOORS. 6. PROVIDE BITUMINOUS DAM PROOFING AT PERIMETER FROM BTM. OF FOOTING TO FINISHED GRADE

7. STEPS IN FOUNDATION WALLS ARE ASSUMED, CONTRACTOR TO FIELD VERIFY LOCATION OF FOUNDATION STEPS AND ADJUST TO ALLOW FOOTING TO BEAR ON UNDISTURBED SOIL.

HYDRONIC RADIANT HEAT NOTES:

1. ALL TUBING SHALL BE SECURED TO WELDED WIRE FABRIC REINFORCING AT INTERVALS NOT EXCEEDING 30" USING WIRE TWIST TIES 2. ALL UNDER-SLAB AREAS SHALL BE INSULATED WITH 1" OF FOAMULAR


250 OR EQUIVALENT 25 PSI RATED EXTRUDED POLYSTYRENE INSULATION. 3. TUBING AND MESH SHALL BE LIFTED DURING POUR TO APPROXIMATE 1/ 2" THICKNESS OF SLAB OTHER THAN AT CONTROL JOINTS. 4. VERIFY THAT MANIFOLD STATIONS ARE INSTALLED WITH ACCESS FROM

DIRECTIONS INDICATED. 5. ALL TUBING SHALL BE SLEEVED AT CONTROL JOINTS CROSSINGS AS SHOWN ON DETAIL.

6. ALL TUBING SHALL BE PRESSURE TESTED TO 75 PSI AIR PRESSURE FOR MINIMUM OF 24 HOURS PRIOR TO CONCRETE POUR.

7. MAINTAIN TUBING A MINIMUM OF 9" AWAY FROM ALL CLOSET FLANGES AND DRAIN TRAPS.

8 VERIFY FLOW DIRECTION AT ALL CIRCUITS (INDICATED BY ARROWS) WHEN CONNECTING TO MANIFOLDS

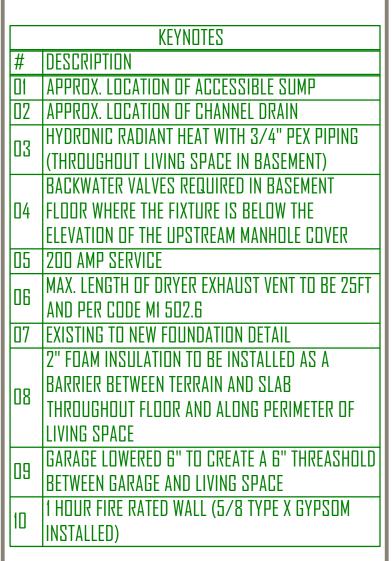

FOOTING, FOUNDATION AND CONCRETE NOTES:

ALL FOOTINGS ARE BASED ON ALLOWABLE SOIL BEARING PRESSURE OF 1500 PSF. FOOTINGS SHALL BEAR ON UNDISTURBED SOIL OR ENGINEERED GRANULAR FILL COMPACTED TO 95% OF MAXIMUM DENSITY. NO FOOTINGS SHALL BE PLACED IN WATER OR FROZEN GROUND. ALL FOOTINGS TO BE PLACE AT MIN. BELOW LOCAL FROST DEPTH, CONTINUOUS AND MONOLITHIC POUR. CHANGES IN ELEV. SHALL BE STEPPED WITH STEP HEIGHT NOT HIGHER THAN 1/2 THE STEP LENGTH AND NOT GREATER THAN 5 FT. MIN. 6" THICKNESS ON VERT. STEP. FOOTINGS TO HAVE 2 #4 BAR CONTINUOUS. NOTIFY ENGINEER IF GRADE DROPS OVER 8 FEET IN 24 FEET (G.T. 1 TO 3 SLOPE) SO THAT APPROPRIATE DESIGN CHANGES MAY BE MADE TO FOUNDATION AND FOOTINGS. ALL FOOTINGS, FOUNDATIONS, AND INTERIOR SLABS SHALL BE NORMAL WT. CONCRETE WITH A COMPRESSIVE STRENGTH EQUAL TO AT LEAST 2,500 PSI WITHIN 28 DAYS AFTER POURING. THE WATER/CEMENT RATIO SHALL BE NO GREATER THAN .50 WITH A MINIMUM CEMENT CONTENT OF 504 LBS. PER CUBIC YARD ALL CONC WORK SHALL BE PLACED, CURED, STRIPPED, AND PROTECTED AS DIRECTED BY THE SPECIFICATIONS AND ACI STANDARDS AND PRACTICES.

ALL REINFORCING SHALL BE DETAILED AND PLACED IN ACCORDANCE WITH ACI STANDARD 318. REINFORCEMENT SHALL BE FREE FROM MUD AND OIL AND OTHER NON-METALLIC COATINGS THAT HAMPER BONDING CAPACITY. ALL SPLICES IN CONTINUOUS REINFORCING SHALL LAP 30 BAR DIAMETERS. VERT & HORZ. #4 BAR (GRADE 60) AS PER FND SCHEDULE. OPENINGS TO HAVE I VERT. #4 BAR EA. SIDE OF OPENING TIED TO HORZ. BAR. 2 #4 BAR ABOVE AND 1 #4 BELOW. WINDOW OPENING EXTENDING 36 BEYOND OPENING. USE ANCHOR BOLTS AS PER FND SCHEDULE USE SIMPSON STHDX(RJ) STRAPS AS NOTED ON DRAWING. OWNER\CONTRACTOR SHALL VERIFY ALL DIMENSIONS AND CONDITIONS LISTED ON THE DRAWING. VERIFICATION OF ALL SITE CONDITIONS INCLUDING SITE STABILITY IS THE RESPONSIBILITY OF OTHERS ALLOW 14 DAYS FOR CONCRETE TO CURE PRIOR TO BACKFILL.

*NOTE: THIS ENGINEERING ASSUMES THAT THE CLEARANCE & SETBACK REQUIREMENTS LISTED IN IRC SECTION R403.1.7 ARE MET. IF THESE PROVISIONS ARE NOT MET, CONTACT THE ENGINEER FOR FURTHER DESIGN.


*NOTE: THIS ENGINEERING ASSUMES THAT THE SITE IS STABLE HAVING NO GLOBAL STABILITY CONCERNS OR HAZARDS. IF THIS IS NOT TRUE THEN CONTACT ENGINEER FOR FURTHER ANALYSIS AND DESIGN.


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GREEN STREET BUILDING ADDITION 2324 South Green Street, Forrest dale 27 & 28 Salt lake cityutah
updated: 2/8/2019
SHEET TITLE: BASEMENT PLAN
SHEET NUMBER:

SCHEDULE:

					VTUDE							
	les.			PLUMBING F	XIURE							
NUMBER	QTY	DESCRIPT	DESCRIPTION COMMENTS									
POI	1	SINK (KIT	INK (KITCHEN)									
P02	5	SINK (SQ	UARE)	[20]								
P03	1	SINK (VAN	NITY)									
P04	4	TOILET (S	TANDA	RD)								
P05	4	TUB (STA	NDARE)) [60W]								
P06	1	WASHER										
P07	1	DRYER VE	NT									
P09	1	MAIN STA	CK									
				תחתם החחם	ספוורם							
		MAIN FLU		FERIOR DOOR								
NUMBER	TYPE		QTY	SIZE		COMMENTS						
DD1	HINGE	D	1	2680 L IN								
D02	HINGE	D	2	2680 R IN								
DO3	HINGE	D	1	2880 R IN								
D04	HINGE	D	4	3080 L IN								
D05	HINGE	D	D 3 3080 R IN									
D07	HINGE	D) 2 3068 L IN									
D08	HINGE	D	1	2668 L IN								

MAIN FLOOR APPLIANCE SCHEDULE TYPE SHEATHING NA NUMBER QTY DESCRIPTION COMMENTS S" CONCRETE FOUNDATION WALL TYPE SHEATHING NA ADI 1 DRYER VENT 2X6 WOOD STUD - w/ INSULATION BATTING - 1 HR FIRE SW-1 7/16" ONE SIDE 8 AD3 1 DRYER 2X4 WOOD STUD - w/ INSULATION BATTING SW-2 7/16" ONE SIDE 8 SW-3 7/16" ONE SIDE 8 SW-3 7/16" ONE SIDE 8	D 6" D.C. 12" D.C. 16 G I 3" D.C. D 4" D.C. 12" D.C. 16 G I 3" D.C. D 3" D.C. 12" D.C. NOT ALLOWED D 2" D.C. 12" D.C. NOT ALLOWED SUBSTITUTED FOR 8D NAILS AT 1/2"	NOTES: CONSTRUCTION NOTES 1. CONTRACTOR TO VERIFY ALL DIMENSIONS ACCORDING TO ANY EXISTING STRUCTURE. 2. CONTRACTOR TO ENGINEER ALL LUMBER SIZES ON SITE PRIOR TO CONSTRUCTION AND INSTALLATION USING THE REQUIREMENTS OF THE CURRENT IRC CODE. ANY SITUATION OF SPAN SIZE THAT IS NOT COVERED IN THE CURRENT IRC PLEASE CONSULT A PROFESSIONAL LICENSED ENGINEER. 3. CONTRACTOR TO VERIFY FINISHED GRADE HEIGHTS. 4. CONTRACTOR TO SET HEIGHT OF GARAGE FLOOR SLAB ACCORDING TO THE FINAL GRADE OF THE HOUSE. 5. CONTRACTOR TO ADJUST GARGE STAIRS TO HOUSE ON HEIGHT OF GARAGE SLAB. HYDRONIC RADIANT HEAT NOTES: 1. ALL TUBING SHALL BE SECURED TO WELDED WIRE FABRIC REINFORCING AT INTERVALS NOT EXCEEDING 30" USING WIRE TWIST TIES 2. ALL UNDER-SLAB AREAS SHALL BE INSULATED WITH I" OF FDAMULAR 250 OR EQUIVALENT 25 PSI RATED EXTRUDED POLYSTYRENE INSULATION. 3. TUBING AND MESH SHALL BE LIFTED DURING POUR TO APPROXIMATE 1/ 2" THICKNESS OF SLAB OTHER THAN AT CONTROL JOINTS. 4. VERIFY THAT MANIFOLD STATIONS ARE INSTALLED WITH ACCESS FROM	COPYRIGHT WARNING: COPYRIGHT WARNING: ALL SUBLIME DESIGN DRAWINGS ARE COPYRIGHTED AND PROTECTED UNDER TITLE 17 OF THE UNITED STATES CODE. NO PART OF THESE DRAWINGS ARE COPYRIGHTED AND FROTECTED UNDER TITLE 17 OF THE UNITED STATES CODE. NO PART OF THESE DRAWINGS AND BE REPRODUCEO TO RTANSMITTED IN ANY FORM OR BY ANY MAANS ELECTRONIC OR MECHANICAL. INCLUDING DRAWING. PHOTOCOPYING, ECORODING. OR ANY INFORMATION STIDRAGE OR RETREIVAL SYSTEM. WITHOUT THE WRITTEN AUTHORIZATION OF SUBLIME DESIGN. THESE DRAWINGS ANNOT ANY MANNER TO CREATE NEW, MODIFIED. ANY VIOLATION ANY MANNER TO CREATE NEW, MODIFIED. ANY VIOLATION ANY MANNER TO CREATE NEW, MODIFIED. OF OR DRAWINGS ANY MANNER TO CREATE NEW, MODIFIED. OF OR DRAWINGS ANY MANNER TO CREATE NEW, MODIFIED. OF OR DRAWINGS ANY MANNER TO CREATE NEW, MODIFIED. OF OR OF OR OF OF OF OF ANY MANNER TO REALTING DESIGN. THESE DRAWINGS ANY MANNER TO CREATE NEW, MODIFIED. OF DRAWINGS ANY MANNER TO CREATE NEW, MODIFIED. OF OF OF OF OF OF OF ANY MANNER TO CREATE NEW, MODIFIED. OF OF OF OF OF OF OF ANY MANNER TO CREATE NEW, MODIFIED. OF OF OF OF OF OF OF ANY MANNER TO CREATE NEW, MODIFIED. OF OF OF OF OF OF OF ANY MANNER TO CREATE NEW, MODIFIED. OF OF OF OF OF OF ANY MANNER TO CREATE NEW, MODIFIED. OF OF OF OF OF OF OF ANY MANNER TO CREATE NEW, MODIFIED. OF OF OF OF OF OF OF OF ANY MANNER TO CREATE NEW, MODIFIED. OF OF OF OF OF OF OF OF ANY MANNER TO CREATE NEW, MODIFIED. OF OF OF OF OF OF OF OF OF ANY MANNER TO CREATE NEW, MODIFIED. OF OF ANY MANNER TO CREATE NEW, MODIFIED. OF OF ANY MANNER TO CREATE NEW AND CREATE NEW
	SUBJECT ALL SUBJECT ALL SUBJE	DIRECTIONS INDICATED. 5. ALL UNDING SHALL BE SLEEVED AT CONTROL JOINTS CROSSINGS AS SNOWN ON OFTAIL. 6. ALL UNDING SHALL BE PRESSURE TESTED TO 75 PSI AIR PRESSURE FOR MINIMUM DF 44 ADORS PROOF CORRECTED AT 7. MAINTAIN TUBING A MINIMUM OF 9" AWAY FROM ALL CLOSET FLANGES AND DRAIN TRAPS. 8 VERIFY FLOW DIRECTION AT ALL CIRCUITS (INDICATED BY ARROWS) WHEN CONNECTING TO MANFOLDS * ENGINEETING TO AMAY FLOM MATURY TO ACCOUNT 1 1/2" CONCRETE SUBFLOOR LOAD INTO ACCOUNT." KEYNOTES # DESCRIPTION OF THE CONCRETENT OF THE ADVENTION OF THE SUBFLOOR LOAD INTO ACCOUNT." KEYNOTES # DESCRIPTION OF THE CODE MISSION OF THE SUBFLOOR LOAD INTO ACCOUNT." KEYNOTES # DESCRIPTION OF THE CODE MISSION OF THE SUBFLOOR LOAD INTO ACCOUNT." KEYNOTES # DESCRIPTION OF THE CODE MISSION OF THE SUBFLOOR LOAD INTO ACCOUNT." KEYNOTES ALL EXTERIOR WALLS AND VERTICAL SUBFLOORS AT STEPS IN ROOF SHALL BE SHALFNED WITH 770% TO REFERE STRUCTURAL WOOD PANELS, BOCKALL HORE CODE WITH 770% TO RUPER, 270 WINDER PRANING AT ADJOINNE PAREL EDGES AND NALLS SHALL BE STAGGERD WHERE BA MAILS ARE DATALESS THAN US' FROM EDGE TO PAREL AND DRIVE ALL MOT FRACTURE THE SUBFLOOR OF PAREL AND DRIVE ALL MOT FRACTURE THE SUBFLOOR OF PAREL AND DRIVE ALL MOT FRACTURE THE SUBFLOOR OF PAREL AND DRIVE ALL MOT FRACTURE THE SUBFLOOR OF PAREL AND DRIVE ALL MOT FRACTURE THE SUBFLOOR OF PAREL AND DRIVE ALL MOT FRACTURE THE SUBFLOOR OF THE SUBME AT ADJOINNE PAREL CONTINUE TO THE SUBFLOOR OF PAREL AND DRIVE ALL MOTES CONTINUE TO THE ATTENT MAN ON ALL TO RUPER 27. WINDER SHALL MOTES SHALL BE FLACED NOT LESS THAN US' FROM EDGE OF PAREL AND DRIVE ALL MOTES CONTINUE TO THE ATTENT MAR ON MAIL TO RUPER 27. MORE ATTENTS ALL EFLACED NOT LESS THAN US' FROM EDGE OF PAREL AND DRIVE ALL MOTES CONTINUES AND USER AND MAILS AND CONTENCTION THE SUBFLOOR THE SUBFLOOR TO THE SUBME STATE OF THE DATE SUBFLOOR TO THE ATTENTS	GREEN STREET BUILDING ADDITION 2324 South Green Street, 2324 South Green Street, 2325 South Green Street, 2325 South Green Street, 2324 South Green Street, 2325 South Greet, 2325 South Street, 2

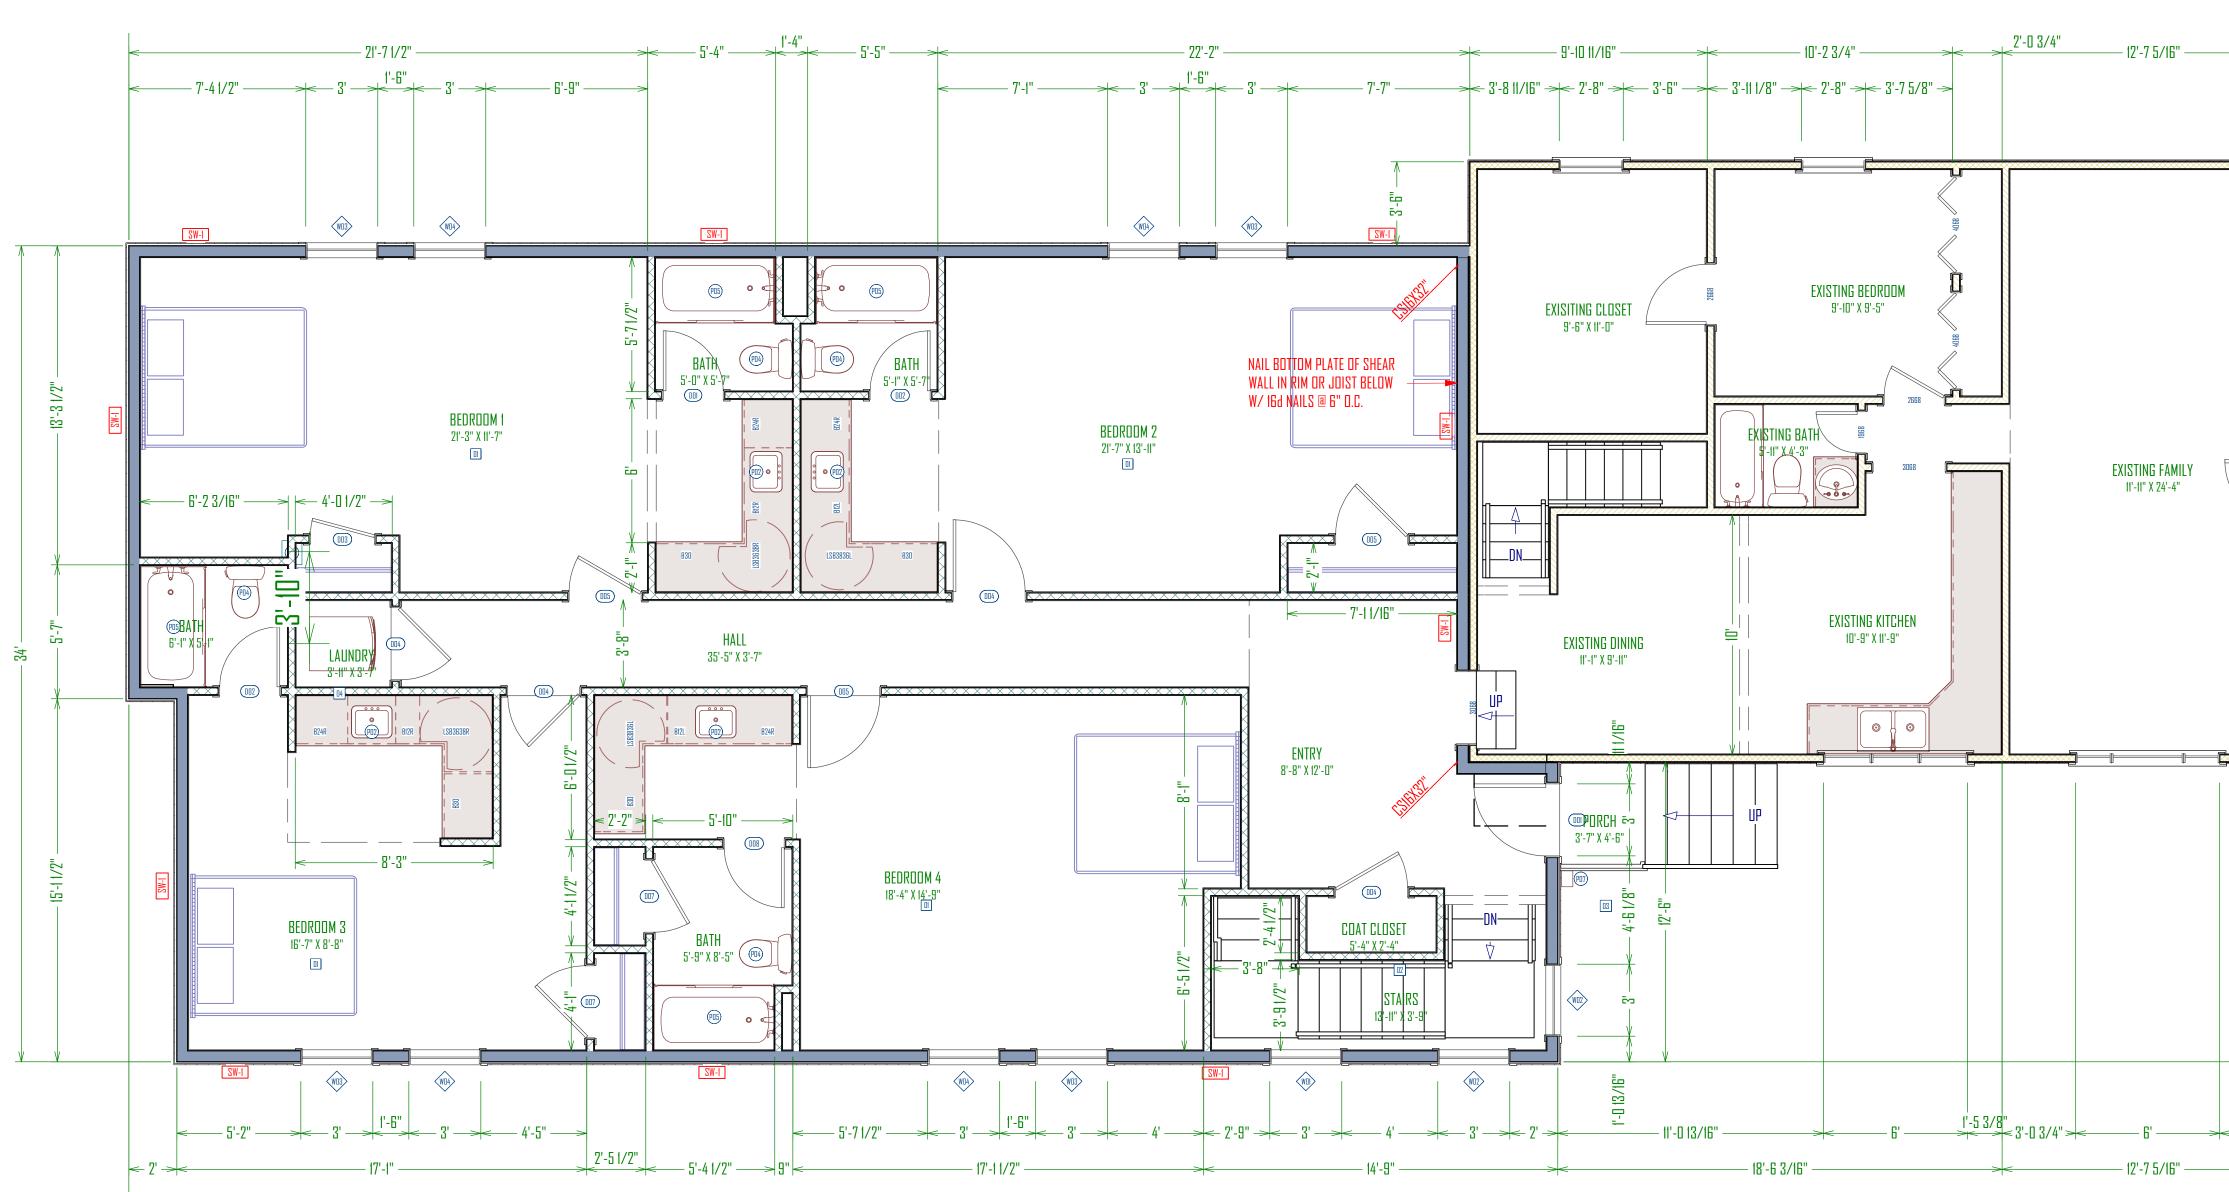

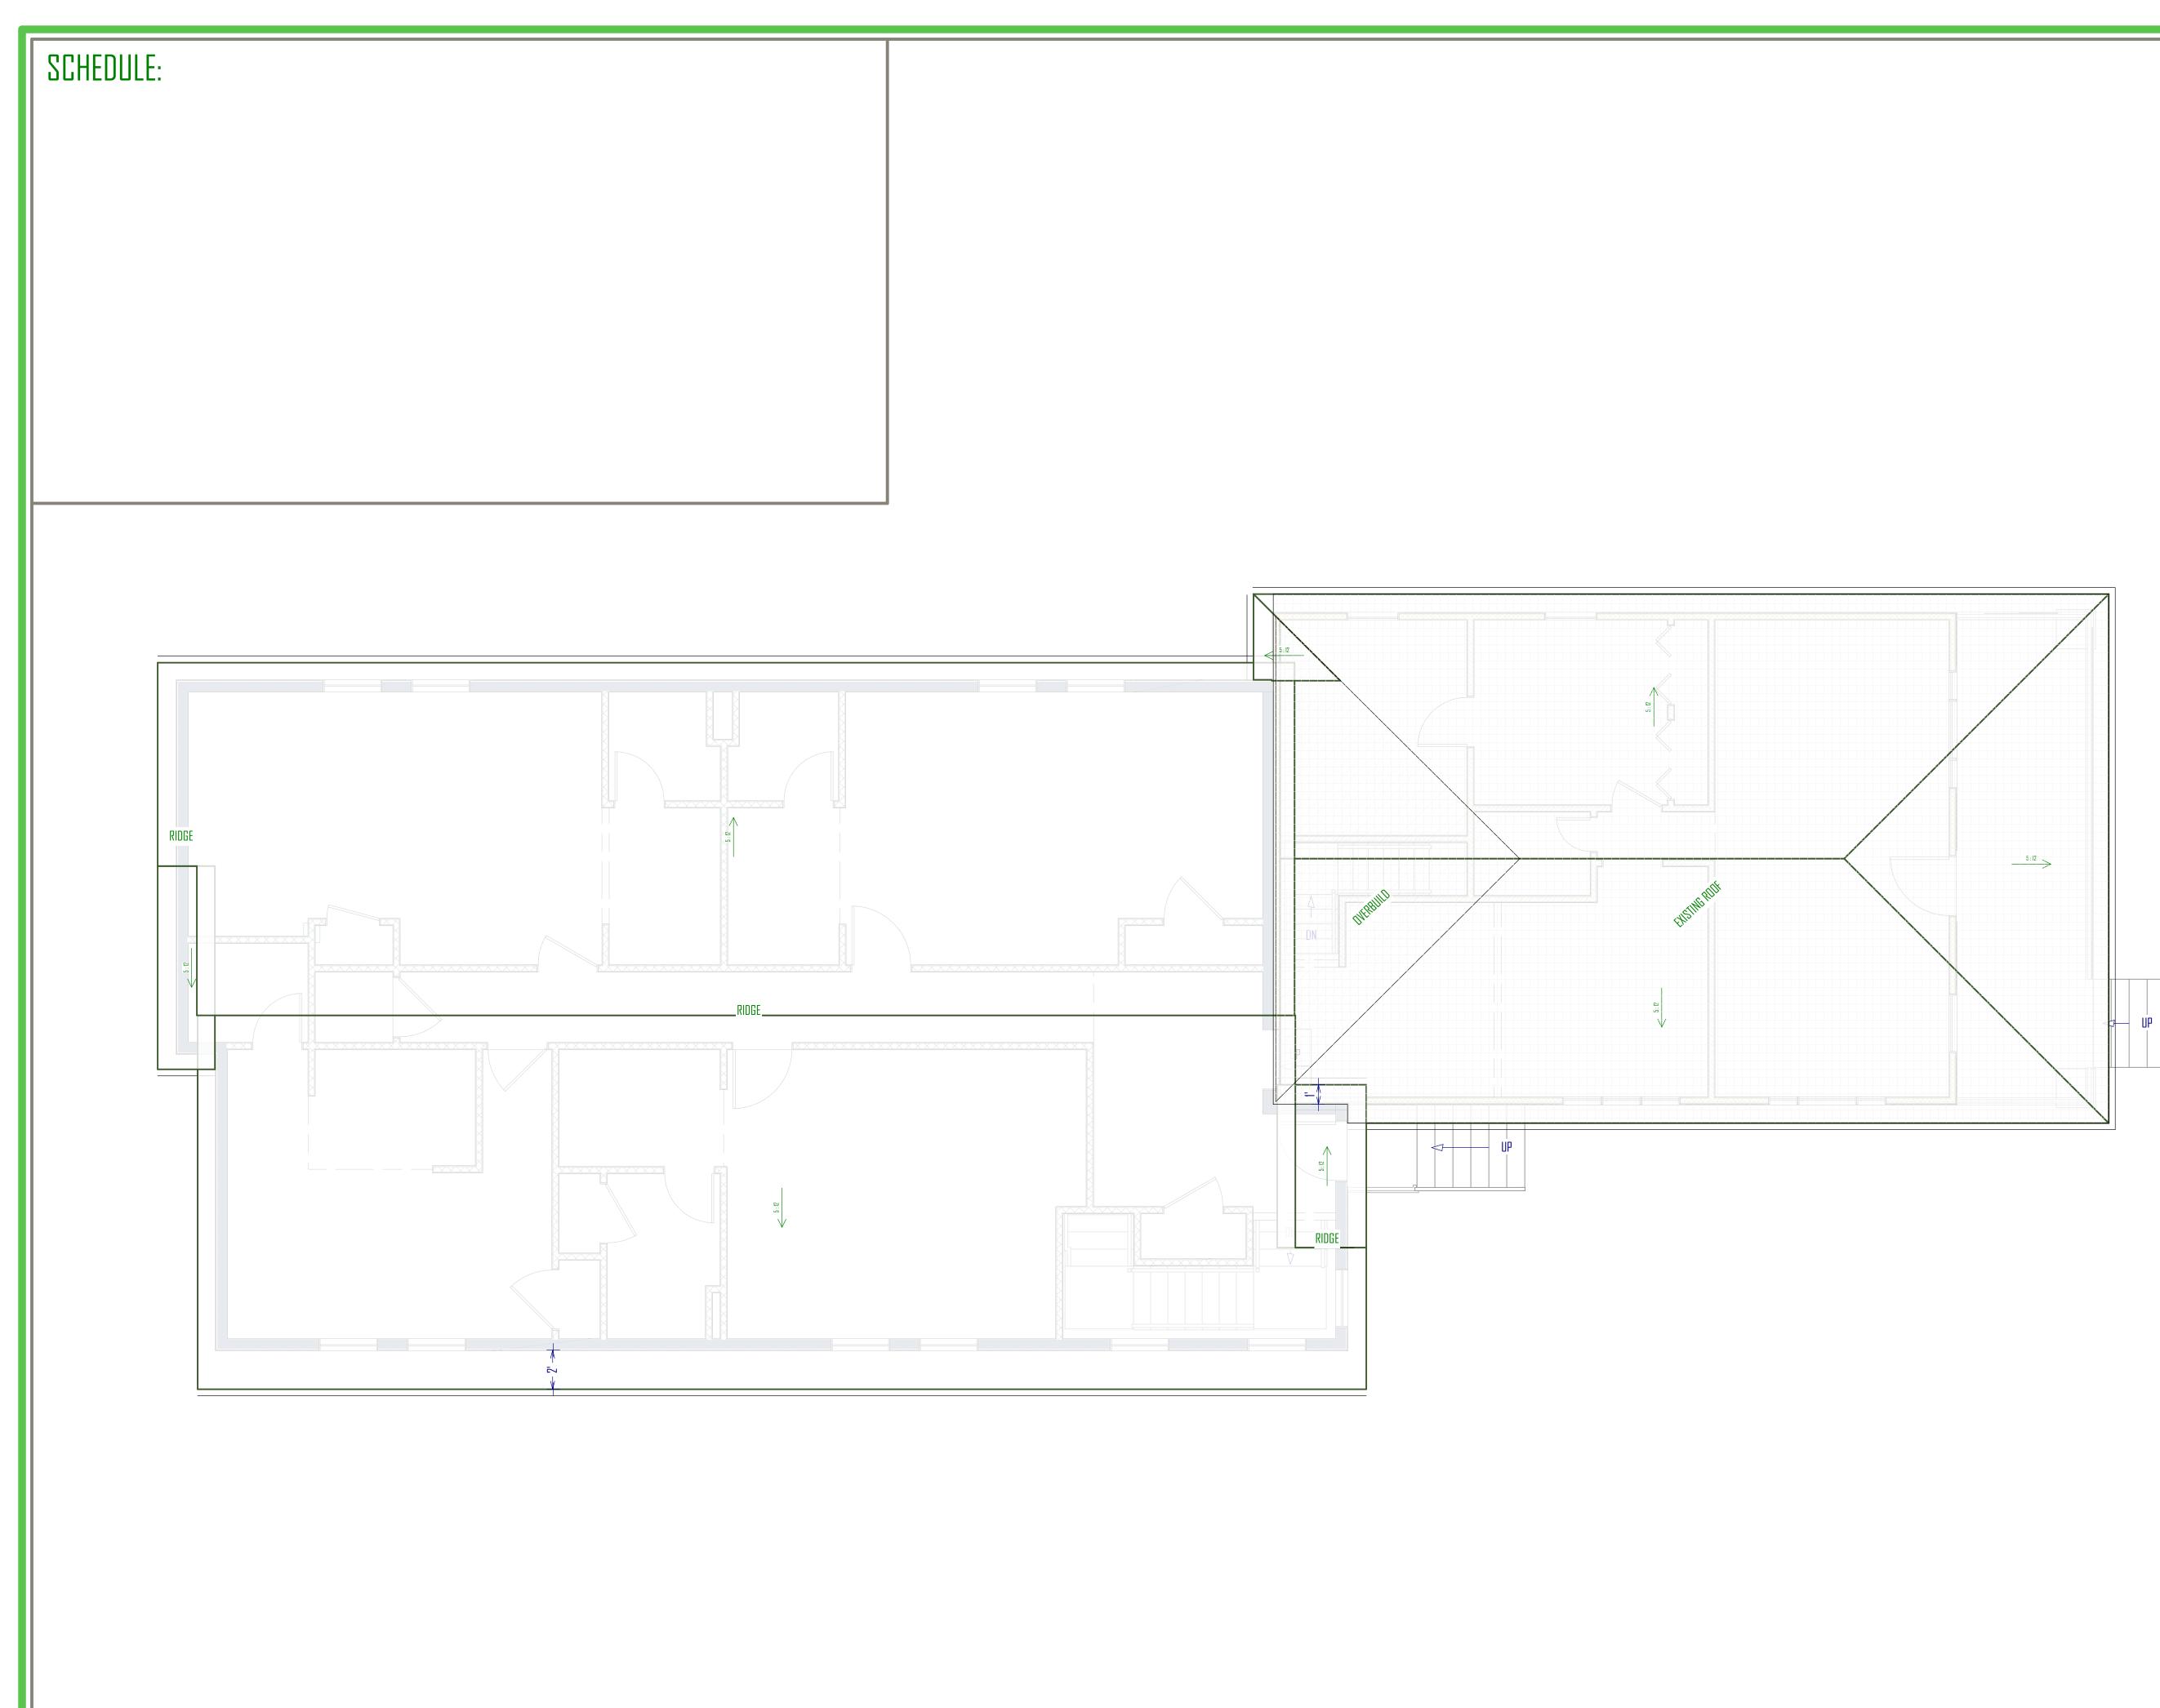

ROOF PLAN SCALE: 1/4"=1'-0"

RODF INFO	RMATION
ROOF STRUCTURE	TRUSS
RODF OVERHANG	1'-0'' UNLESS OTHERWISE NOTED
WALL PLATE HEIGHT	10'-0"

NOTES: General rodf notes

** THE FOLLOWING NOTES ARE A MINIMUM PER CODE. ANY DESIGN OR INSTRUCTION BY A LICENSED ENGINEER WILL SUPERCEDE THESE NOTES.)

1. ARCHITECTURAL GRADE ASPHALT SHINGLES ON #30 FELT OR EQUIVALENT, OVER ROOF SHEETING. 2. 6" ALUMINUM FASCIA W/ CONTINUOUS VENTED SOFFIT TO MATCH.

3. GABLE VENTS WHERE SHOWN ON PLAN (OWNERS CHOICE) 4. RODF VENTILATION SHALL BE 1 SQ. FT. OF VENT FOR EVERY 150 SQ FT. OF ATTIC AREA

5. ALUMINUM GUTTER AND DOWN SPOUTS THROUGHOUT, COORDINATE WITH OWNER.

VENTING NOTES:

CONTRACTOR TO VERIFY PROPER CEILING CAVITY VENTING PROCEDURES PER MANUFACTURERS SPECIFICATIONS WITH COMBINATIONS USE OF SOFFIT VENTING PROVIDED AT 1/300 OF ROOF AREA.

NOT LESS THAN 40 PERCENT AND NOT MORE THAN 50 PERCENT OF THE REQUIRED VENTILATING AREA IS PROVIDED BY VENTILATORS LOCATED IN THE UPPER PORTION OF THE ATTIC OR RAFTER SPACE. UPPER VENTILATORS SHALL BE LOCATED NOT MORE THAN 3 FEET BELOW THE RIDGE OR HIGHEST POINT OF THE SPACE, MEASURED VERTICALLY, WITH THE BALANCE OF THE REQUIRED VENTILATION PROVIDED BY EAVE OR CORNICE VENTS. WHERE THE LOCATION OF WALL OR ROOF FRAMING MEMBERS CONFLICTS WITH THE INSTALLATION OF UPPER VENTILATORS, INSTALLATION MORE THAN 3 FEET BELOW THE RIDGE OR HIGHEST POINT OF THE SPACE SHALL BE PERMITTED.

TOTAL ROOF AREA = 1940 SF TOTAL REQUIRED VENTILATION = 6.467

VENTILATORS LOCATED IN UPPER PORTION OF ATTIC TO PROVIDE:

NOT LESS THAN 2.59 SF (40%) NDT MORE THAN 3.23 SF (50%)

July
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GREEN STREET BUILDING ADDITION 2324 SDUTH GREEN STREET, FORREST DALE 27 & 28 SALT LAKE CITYUTAH
updated: 2/13/2019 Sheet title: LOWER ROOF
PLAN SHEET NUMBER: A-4



NOTES:

GENERAL STAIR NOTES

1. RISER HEIGHT: THE MAXIMUM RISER HEIGHT SHALL BE 7 3/4". the RI SHALL BE MEASURED VERTICALLY BETWEEN LEADING EDGES OF THE ADJACENT TREADS. THE GREATEST RISER HEIGHT WITHIN ANY FLIGHT OF STAIRS SHALL NOT EXCEED THE SMALLEST BY MORE THAN 3/8". 2. TREAD DEPTH: THE MINIMUM TREAD DEPTH SHALL BE 10". tHE TREAD DEPTH SHALL BE MEASURED HORIZONTALLY BETWEEN THE VERTICAL PLANES OF THE FOREMOST PROJECTION OF ADJACENT TREADS AND AT A RIGHT ANGLE TO THE TREAD'S LEADING EDGE. THE GREATEST TREAD DEPTH WITHIN ANY FLIGHT OF STAIRS SHALL NOT EXCEED THE SMALLEST BY MORE THAN 3/8TH INCH.

3. WINDER TREADS: WINDER TREADS SHALL HAVE A MINIMUM TREAD DEPTH OF IO" MEASURED AS ABOVE AT A POINT 12 INCHES FROM THE SIDE WHERE THE TREADS ARE NARROWER. WINDER TREADS SHALL HAVE A MINIMUM TREAD DEPTH OF 6" AT ANY POINT. WITHIN ANY FLIGHT OF STAIRS. THE LARGEST WINDER TREAD DEPTH AT THE 12 INCH WALK LINE SHALL EXCEED THE SMALLEST BY MORE THAN 3/8TH INCH

4. LANDINGS FOR STAIRWAYS: THERE SHALL BE A FLOOR OR LANDING AT THE TOP AND BOTTOM OF EACH STAIRWAY. EXCEPTION: A FLOOR OR LANDING IS NOT REQUIRED AT THE TOP OF AN INTERIOR FLIGHT OF STAIRS, INCLUDING STAIRS IN AN ENCLOSED GARAGE, PROVIDED A DOOR DOES NOT SWING OVER THE STAIRS.

5. A FLIGHT OF STAIRS SHALL NOT HAVE A VERTICAL RISE LARGER THAN 12' BETWEEN FLOOR LEVELS OR LANDINGS.

6. THE WIDTH OF EACH LANDING SHALL NOT BE LESS THAN THE WIDTH OF THE STAIRWAY SERVED. EVERY LANDING SHALL HAVE A MINIMUM DIMENSION OF 36" MEASURED IN THE DIRECTION OF TRAVEL.

7. STAIRWAY WALKING SURFACE: THE WALKING SURFACE OF TREADS AND LANDINGS OF STAIRWAYS SHALL BE SLOPED NO STEEPER THAN ONE UNIT VERTICAL IN 48: HORIZONTAL (2 % SLOPE)

8.HANDRAILS: HANDRAILS SHALL BE PROVIDED ON AT LEAST ONE SIDE OF EACH CONTINUOUS RUN OF TREADS OR FLIGHT WITH FOUR OR MORE RISERS.

I. HANDRAIL HEIGHT: HANDRAIL HEIGHT, MEASURED VERTICALLY FROM TH SLOPED PLANE ADJOINING THE TREAD NOSING, OR FINISH SURFACE OF RAMP SLOPE, SHALL BE NOT LESS THAN 34" AND NOT MORE THAN 38". IO. CONTINUITY. HANDRAILS FOR STAIRWAYS SHALL BE CONTINUOUS FOR THE FULL LENGTH OF THE FLIGHT, FROM A POINT DIRECTLY ABOVE THE TOP RISER OF THE FLIGHT TO A POINT DIRECTLY ABOVE THE LOWEST RISER OF THE FLIGHT.

11. HANDRAIL ENDS SHALL BE RETURNED OR SHALL TERMINATE IN NEWEL POSTS OR SAFETY TERMINALS. 12. HANDRAILS ADJACENT TO A WALL SHALL HAVE A SPACE OF NOT LESS


THAN 1 1/2" BETWEEN THE WALL AND THE HANDRAILS. EXCEPTIONS:

A. HANDRAIL SHALL BE PERMITTED TO BE INTERRUPTED BY A NEWEL POST AT THE TURN. B. THE USE OF A VOLUTE, TURNOUT, STARTING EASING OR STARTING NEWEL


SHALL BE ALLOWED OVER THE LOWEST TREAD.






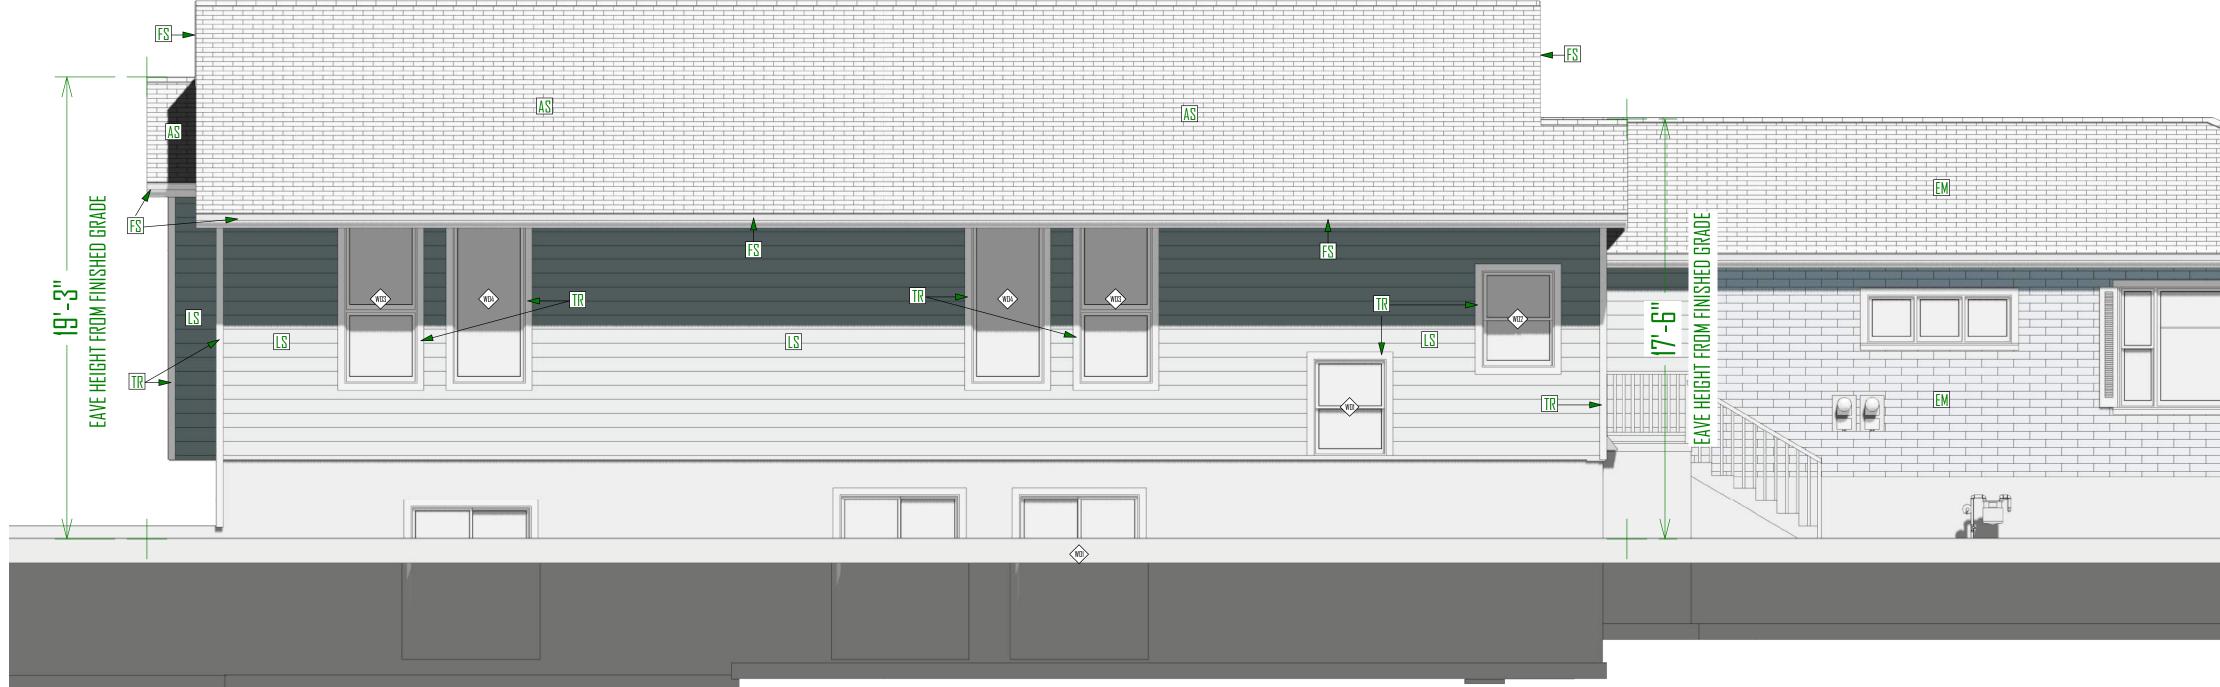


EAST ELEVATION - FRONT SCALE: 1/4"=1'-0"

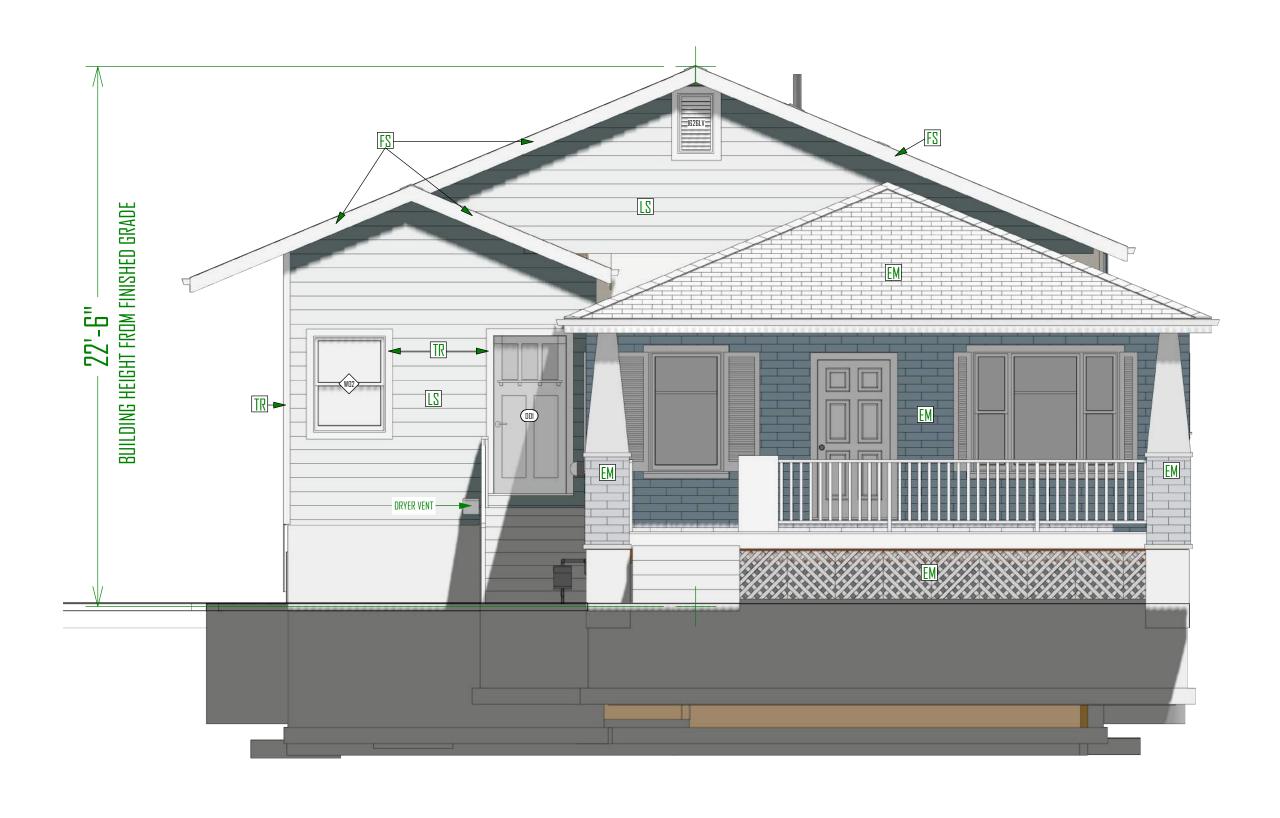

NOTES: IS - FIBER DEMENT LAP SIDING MANUFACTURE: TBD SERVES: TBD CLUDR: TBD NOTES: IR - FIBER DEMENT FASCIA & SOFFT MANUFACTURE: TBD SERVES: TBD CLUDR: TBD NOTES: FS - FIBER CEMENT FASCIA & SOFFT MANUFACTURE: TBD SERVES: TBD CLUDR: TBD NOTES: FS - FIBER CEMENT FASCIA & SOFFT MANUFACTURE: TBD SERVES: TBD CLUDR: TBD NOTES: FS - FIBER CEMENT FASCIA & SOFFT MANUFACTURE: TBD SERVES: TBD CLUDR: TBD NOTES: FS - FIBER CEMENT FASCIA & SOFFT MANUFACTURE: TBD SERVES: TBD CLUDR: TBD NOTES: FS - FIBER CEMENT FASCIA & SOFFT MANUFACTURE: TBD SERVES: TBD CLUDR: TBD NOTES: FS - FIBER CEMENT FASCIA & SOFFT MANUFACTURE: TBD SERVES: TBD CLUDR: TBD NOTES: FS - FIBER CEMENT FASCIA & SOFFT MANUFACTURE: TBD SERVES: TBD CLUDR: TBD NOTES: FS - FIBER CEMENT FASCIA & SOFFT MANUFACTURE: TBD SERVES: TBD CLUDR: TBD NOTES: FS - FIBER TBD CLUDR: TBD NOTES: FS - FIBER CEMENT FASCIA & SOFFT MANUFACTURE: TBD SERVES: TBD CLUDR: TBD NOTES: FS - FIBER CEMENT FASCIA & SOFFT MANUFACTURE: TBD SERVES: TBD CLUDR: TBD NOTES: FS - FIBER TBD SERVES: TBD CLUDR: TBD NOTES: FS - FIBER TBD CLUDR: TBD NOTES: FS - FIBER TBD SERVES: TBD CLUDR: TBD NOTES: FS - FIBER TBD SERVES:		
2/8/2019 Sheet title: ELEVATION EAST & SOUTH Sheet number:	 LS - FIBER CEMENT LAP SIDING MANUFACTURE: TBD SERIES: TBD COLOR: TBD NOTES: TR - FIBER CEMENT TRIM MANUFACTURE: TBD SERIES: TBD COLOR: TBD NOTES: FIBER CEMENT FASCIA & SOFFIT MANUFACTURE: TBD SERIES: TBD COLOR: TBD NOTES: AS - ASPHALT ROOF SHINGLES MANUFACTURE: TBD SERIES: TBD COLOR: TBD NOTES: EX - *EXISTING BUILDING MATERIALS & COLORS - TO REMAIN AS IS 	LDING ADDITION Reen street, E 27 & 28 Cityutah
SHEET NUMBER:		2/8/2019 Sheet TITLE:
		& SOUTH Sheet number:

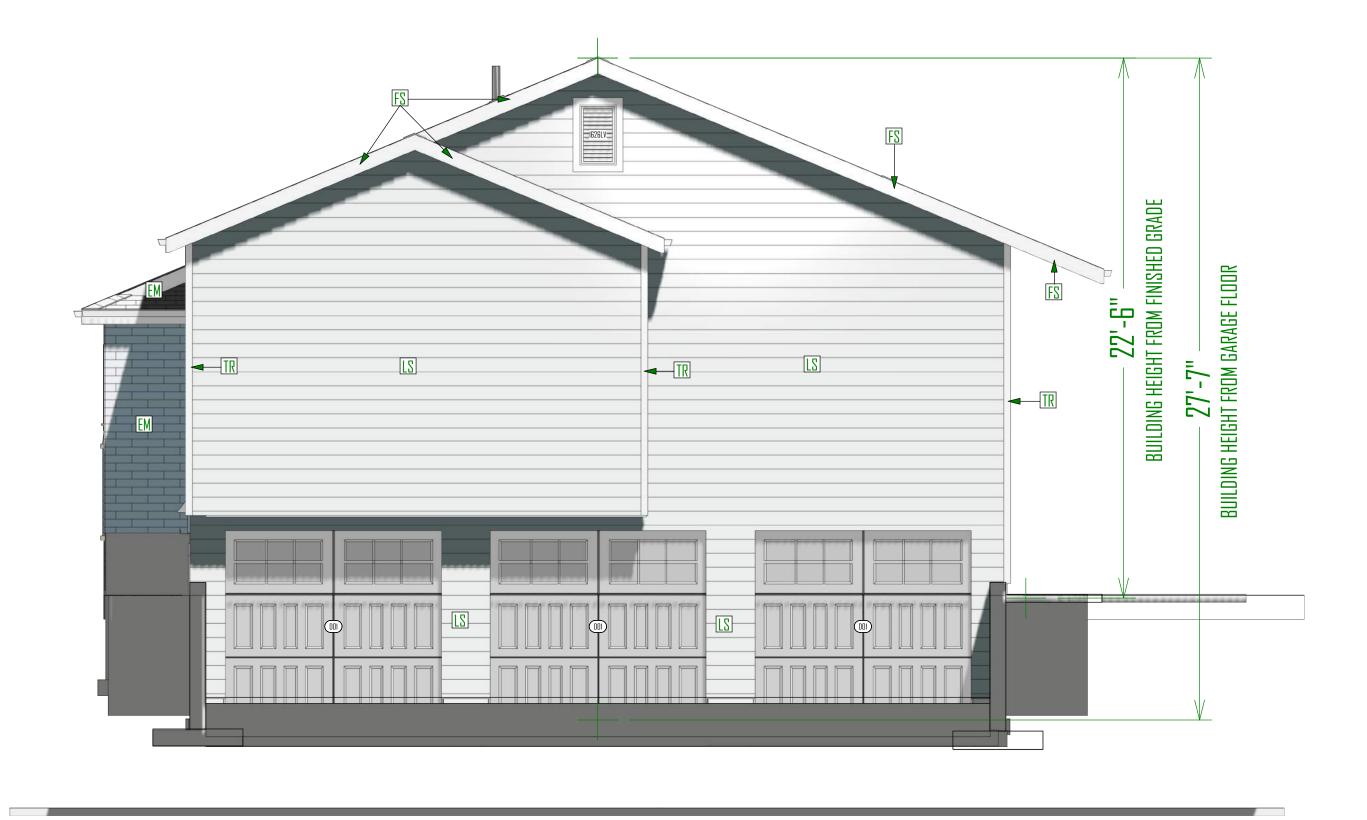


WEST ELEVATION - REAR SCALE: 1/4"=1'-0"

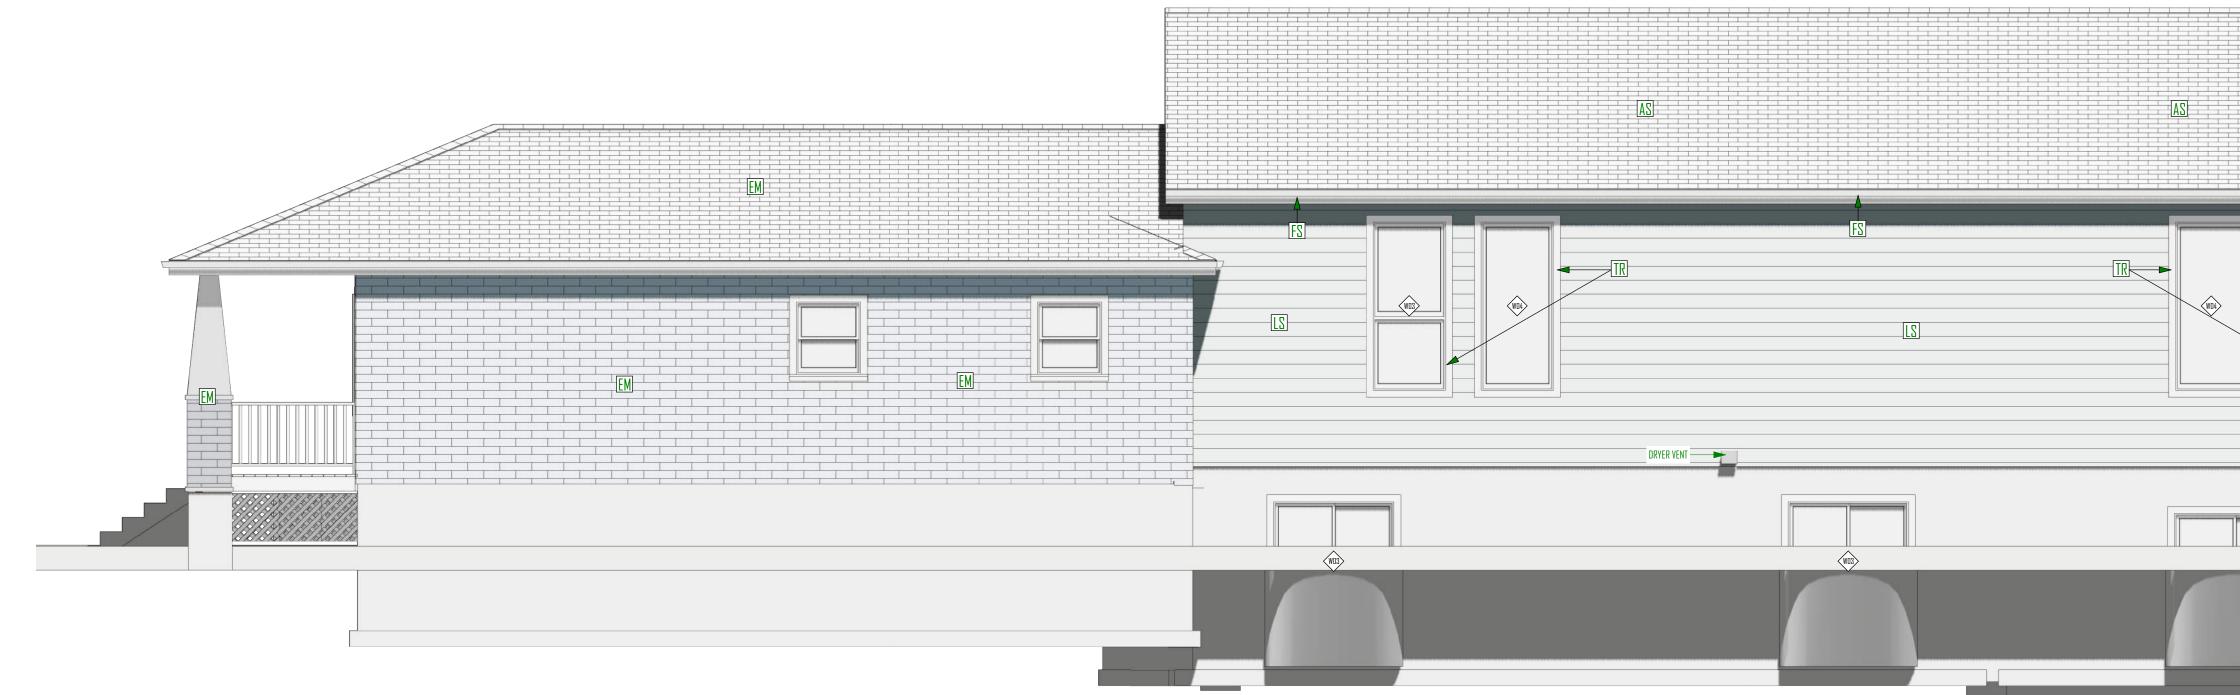


NORTH ELEVATION - RIGHT SCALE: 1/4"=1'-0"

NOTES: LS - FIBER CEMENT LAP SIDING MANUFACTURE: TBD SERIES: TBD COLOR: TBD NOTES: TR - FIBER CEMENT TRIM MANUFACTURE: TBD SERIES: TBD COLOR: TBD NOTES: FS - FIBER CEMENT FASCIA & SOFFIT MANUFACTURE: TBD SERIES: TBD	CDPYRIGHT WARNING: CDPYRIGHT WARNING: ALL SUBLIME DESIGN DRAWINGS ARE CDPYRIGHTED AND PROTECTED UNDER TITLE I'T OF THE UNITED STATES CODE. NO PART OF THESE DRAWINGS MAY BE REPRODUCED OR TRANSMITTED IN ANY FORM DR BY ANY MEANS ELECTRONIC DR MECHANICAL. INCLUDING DRAWING. RECORDING. OR ANY NEGRMATION STIORAGE OR RETRIEVAL SYSTEM. WITHOUT THE WRITTEN DR MECHANICAL. INCLUDING DRAWING. RECORDING. OR ANY NEGRMATION STIORAGE OR RETRIEVAL SYSTEM. WITHOUT THE WRITTEN AUTHORIZATION OF SUBLIME DESIGN. THESE DRAWINGS MANNES MANNER TO CREATE NEW. MODIFIED. OR DERIVATIVE DRAWINGS MITHOUT ANY MANNER TO CREATE NEW. MODIFIED. OR DERIVATIVE DRAWINGS MANNER TO CREATE NEW. MODIFIED. OR DERIVATIVE DRAWINGS MANNES TO CREATE NEW. MODIFIED. OR DRAWINGS MANNES TO CREATE NEW. MODIFIED. OR DRAWINGS MANNES TO CREATE NEW. MODIFIED. DRAWINGS MA
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	updated: 2/8/2019 Sheet title: ELEVATION WEST & NORTH Sheet number: A-7

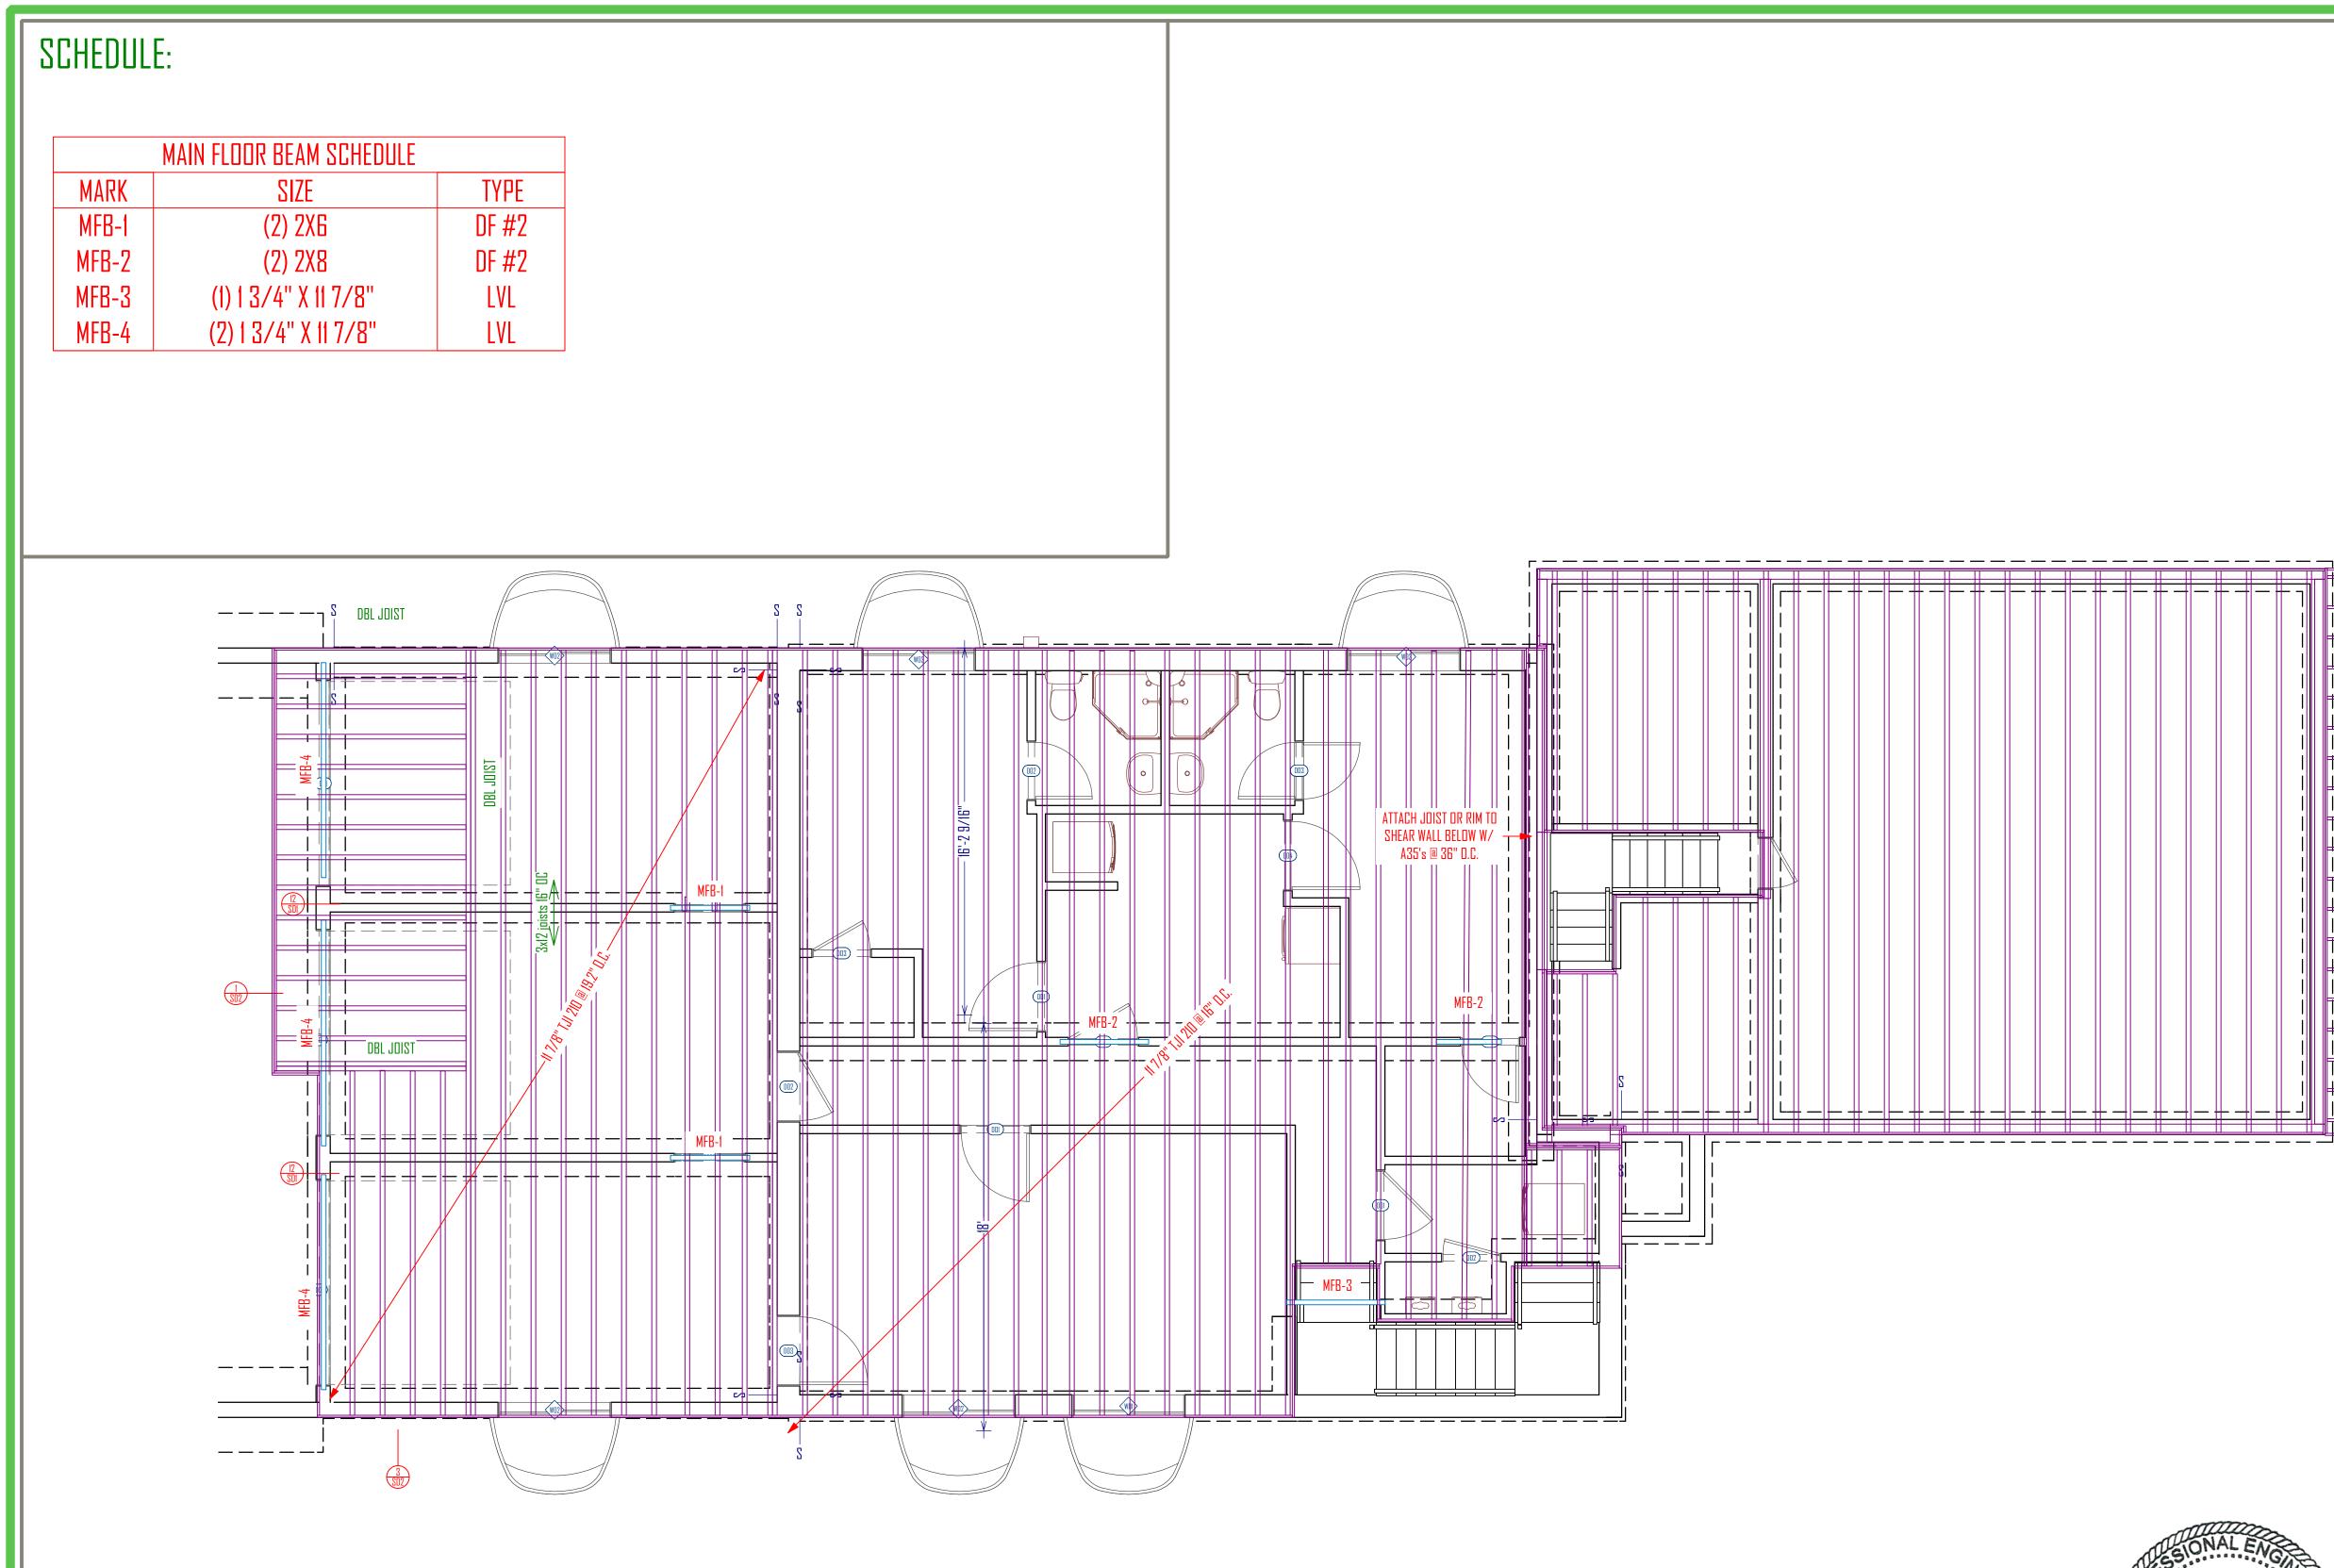

MAIN FLOOR FRAMING PLAN SCALE: 1/4"=1'-0"

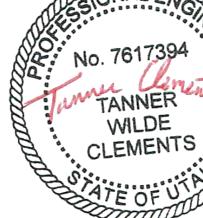

WILDE

I-JOISTS


11 7/8"

10'-0"

MAIN FLOOR INFORMATION FLOOR STRUCTUR JOIST DEPTH WALL PLATE HEIGHT






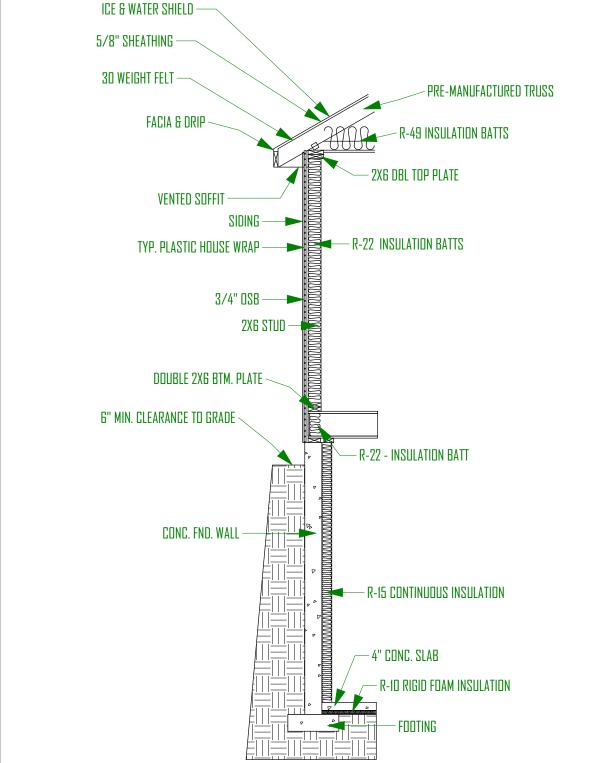





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ROOF FRAMING PLAN SCALE: 1/4"=1'-0" UPPER F FLOOR STRUCTURE JOIST DEPTH WALL PLATE HEIGHT

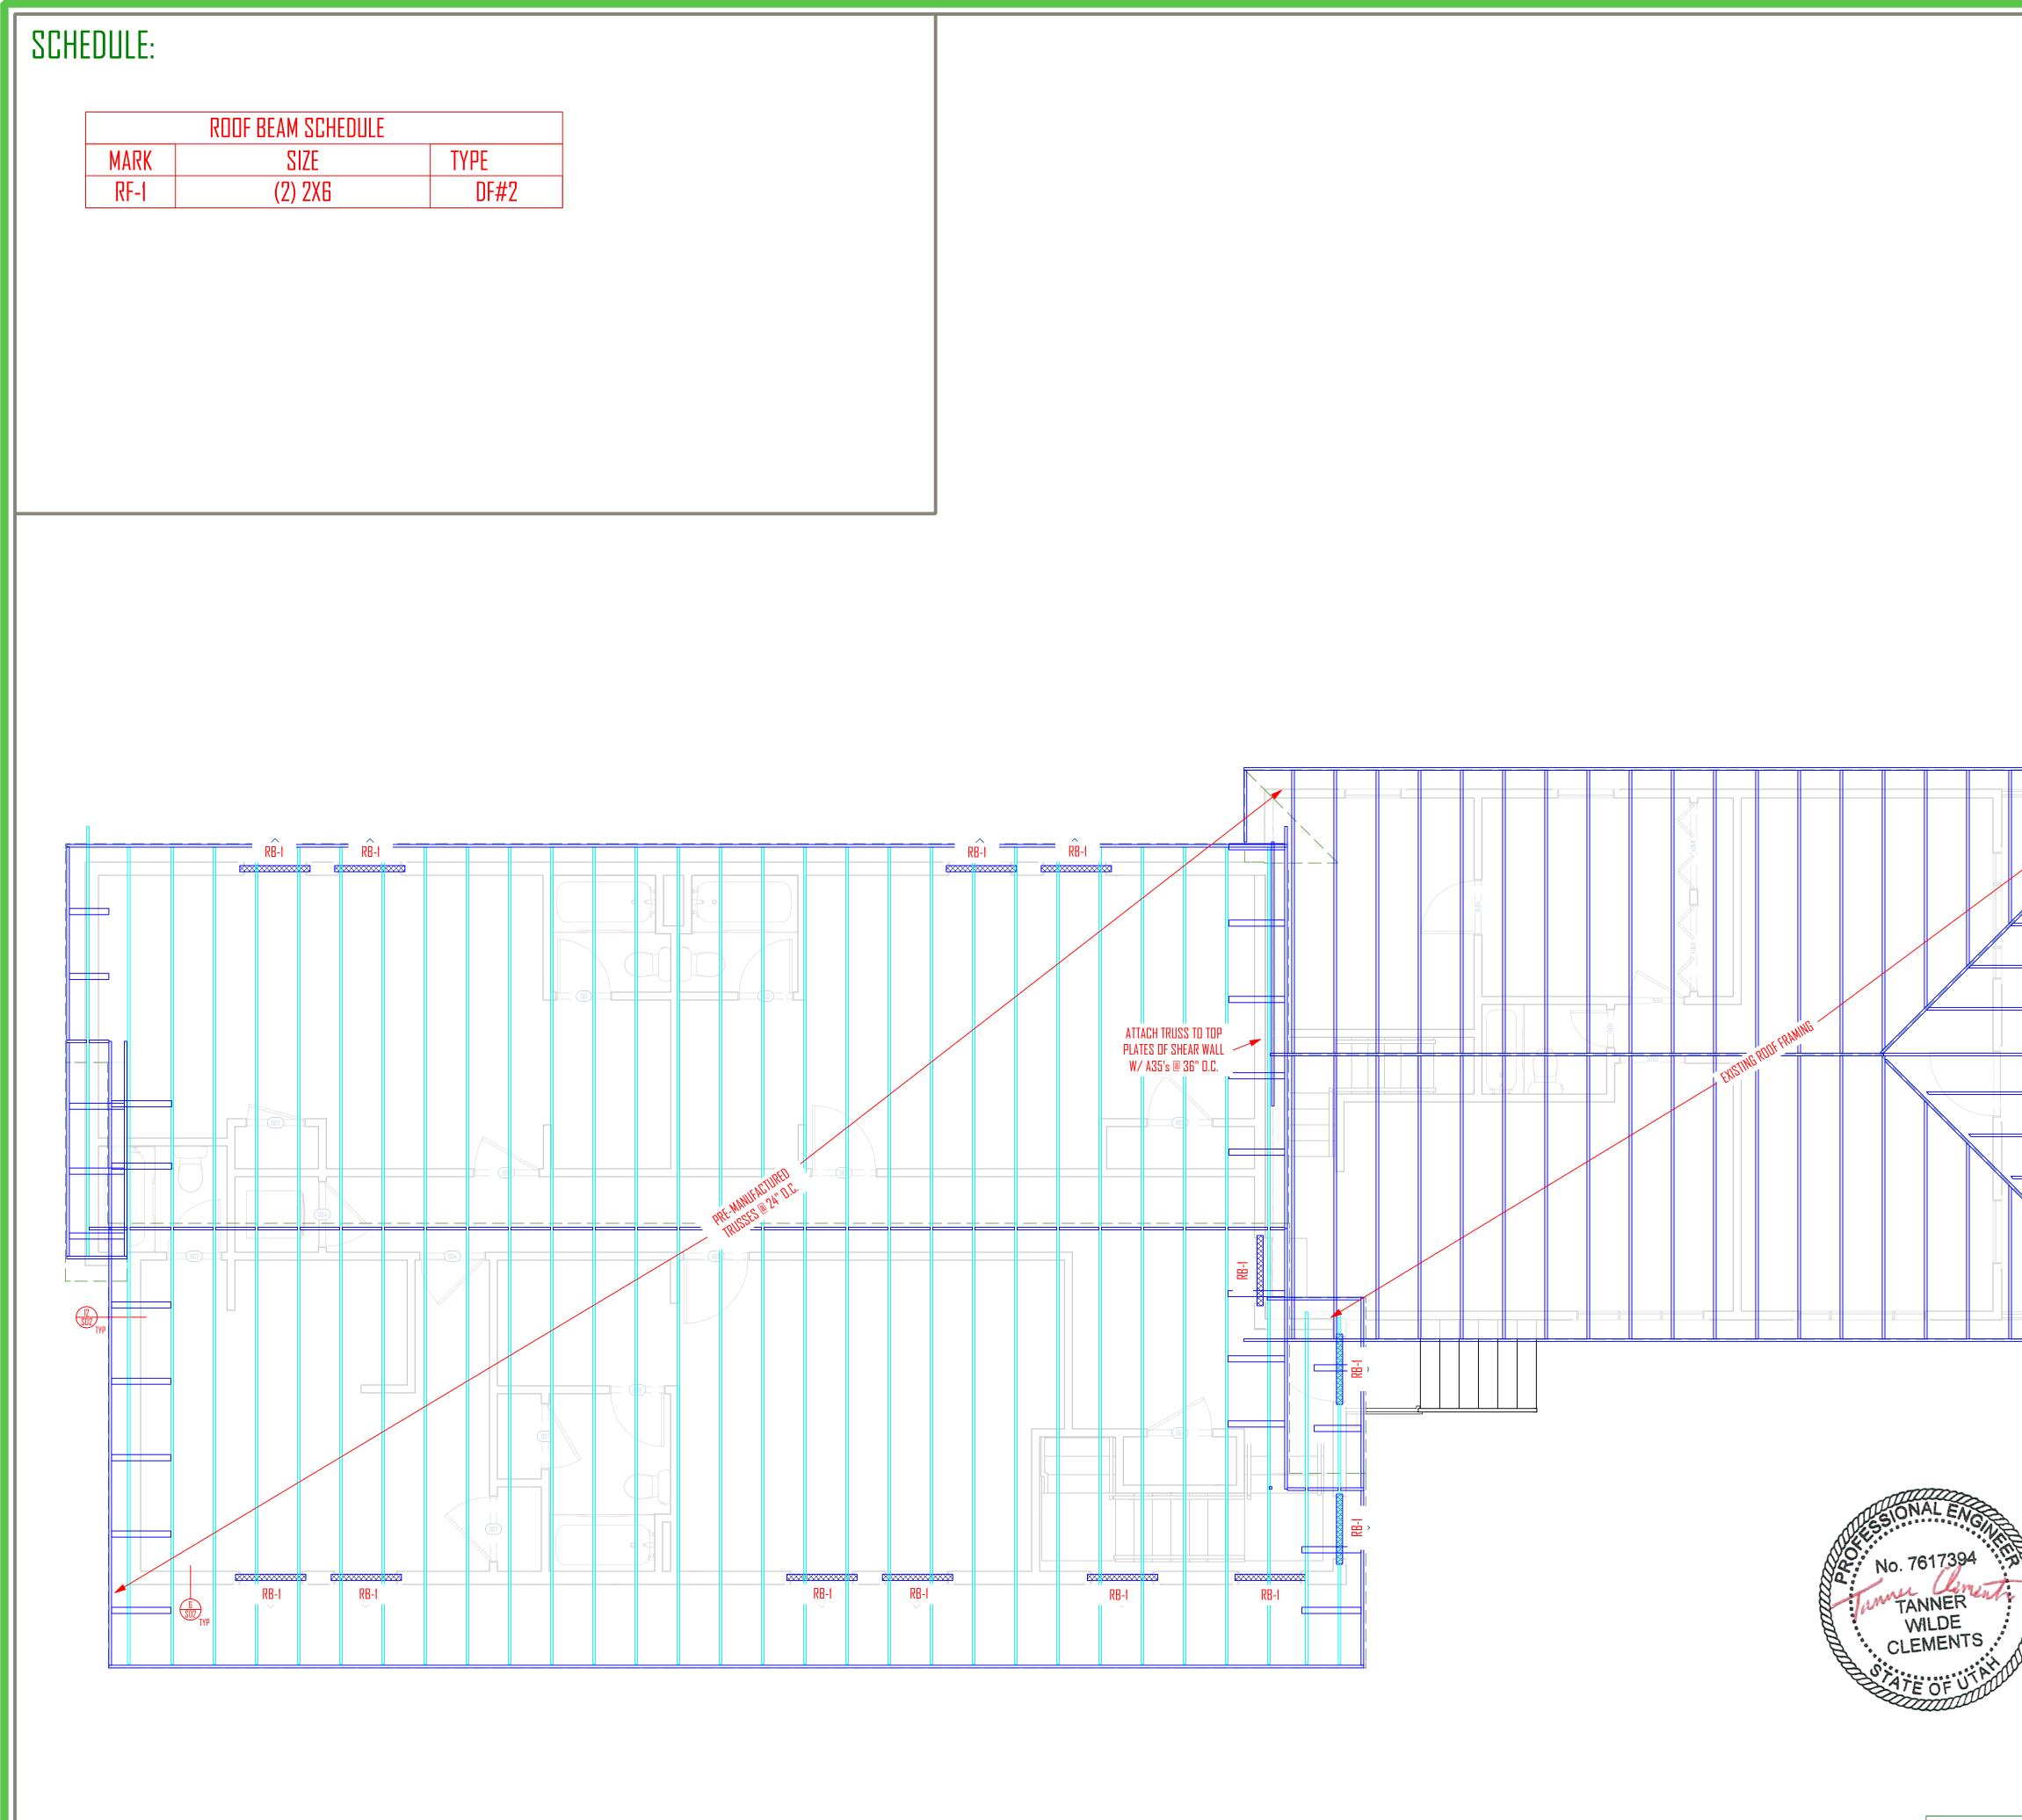

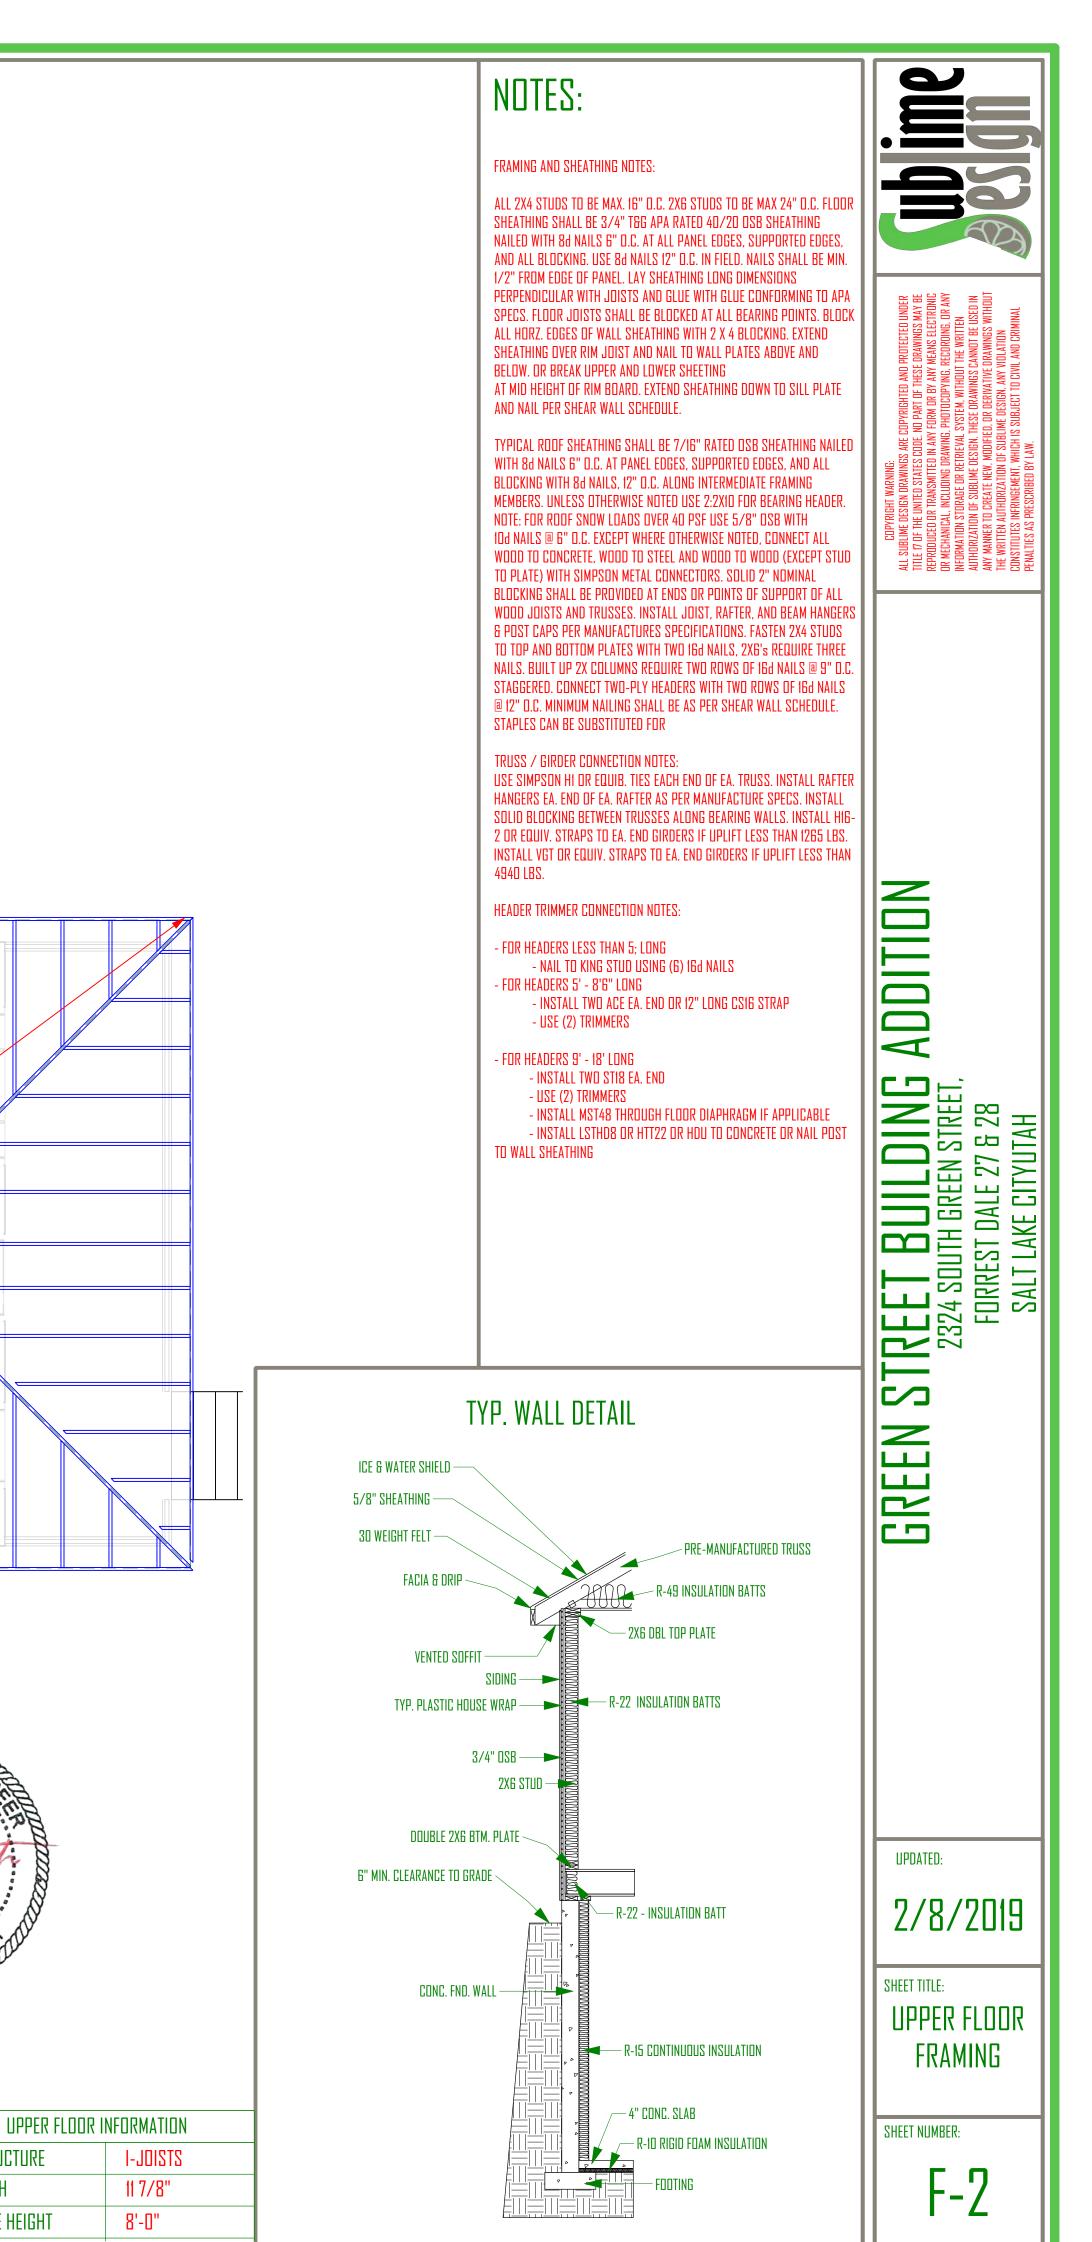

SCHEDULE:

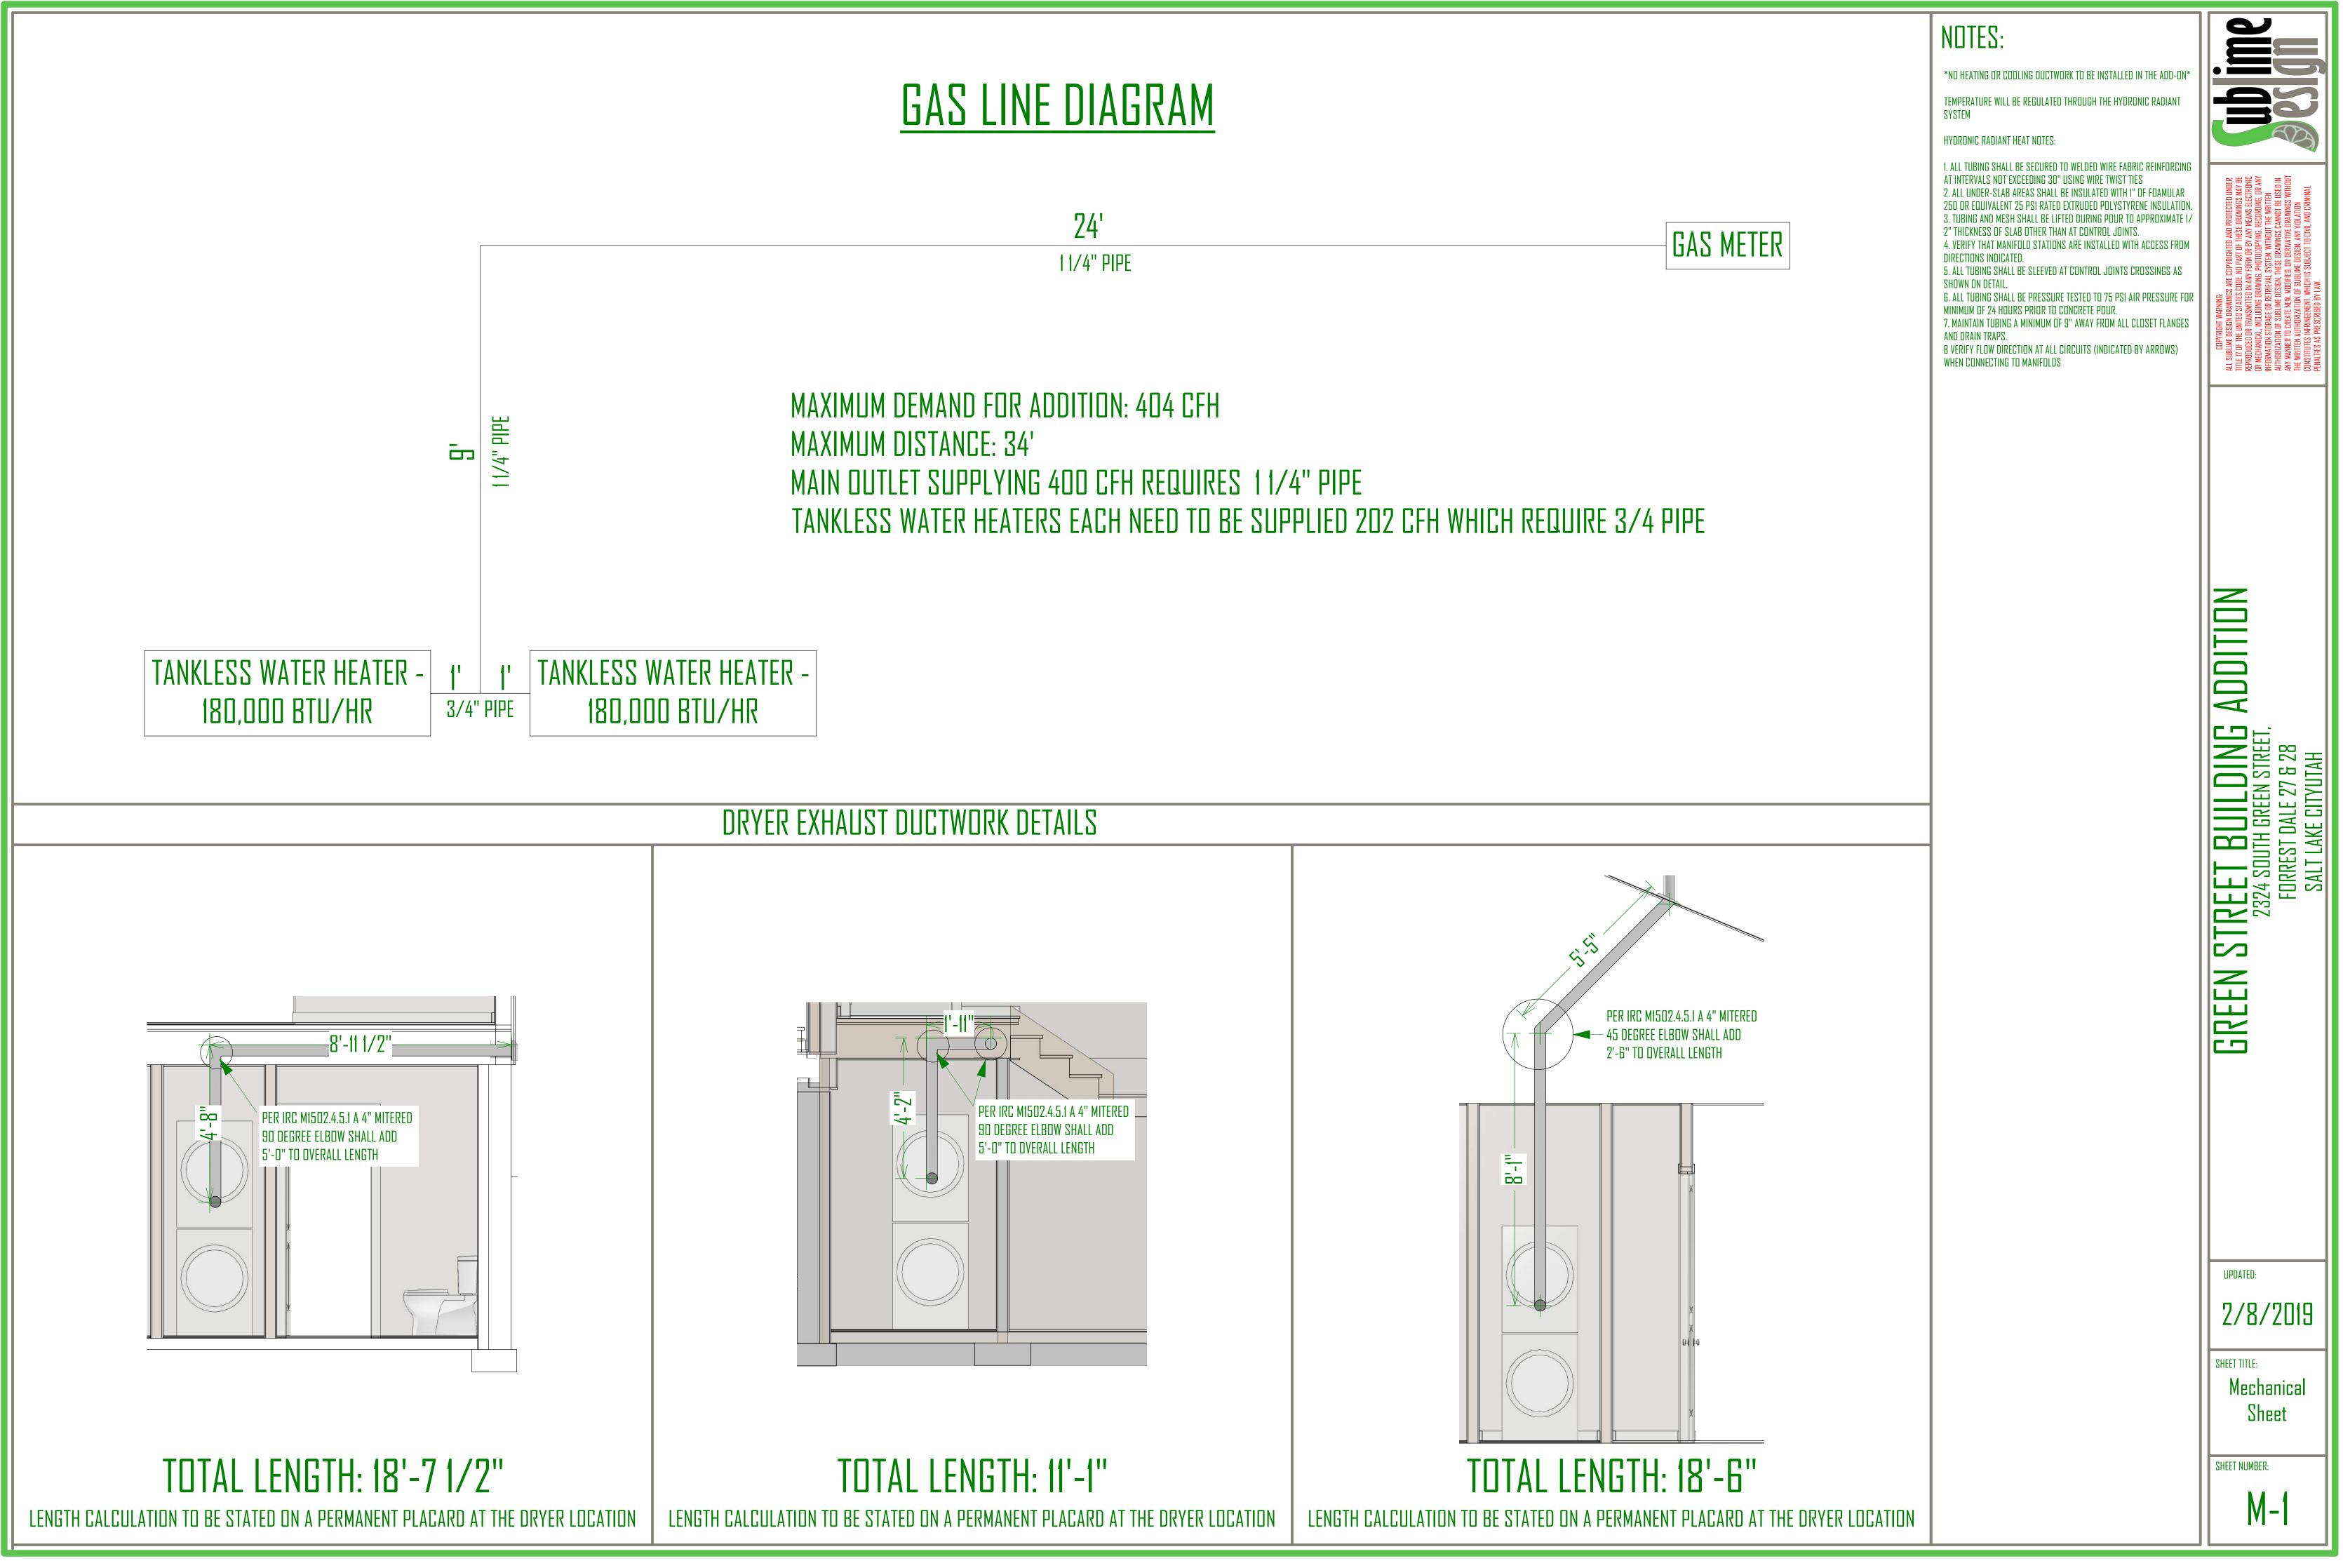
	MAIN FLOOR PLUMBING FIXTURES			
NUMBER	QTY	DESCRIPTION	COMMENTS	
P01	1	SINK (KITCHEN)		
P02	5	SINK (SQUARE) [20]		
P03	1	SINK (VANITY)		
P04	4	TDILET (STANDARD)		
P05	4	TUB (STANDARD) [60W]		
P06	1	WASHER		
P07	1	DRYER VENT		
P09	1	MAIN STACK		

BASMENT PLUMBING FIXTURES


NUMBER	QTY	DESCRIPTION	COMMENTS
POI	2	CHAMFER CORNER SHOWER	
PN2	ŋ	K-2293-8 WELLWORTH PEDESTAL	
PUZ		BATHROOM SINK	
P03	1	SINK (SQUARE) [20]	
P04	2	TOILET (STANDARD)	
P05	2	WASHER	
P06	1	DRYER VENT	


BASEMENT / ADU BATHROOMS


SCALE: 1/2"=1'-0"

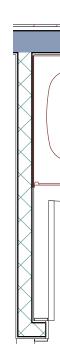


MAIN FLOOR / BATHROOMS SCALE: 1/2"=1'-0"

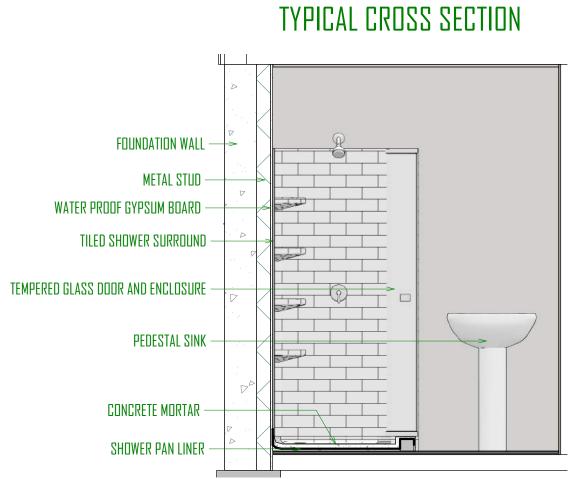


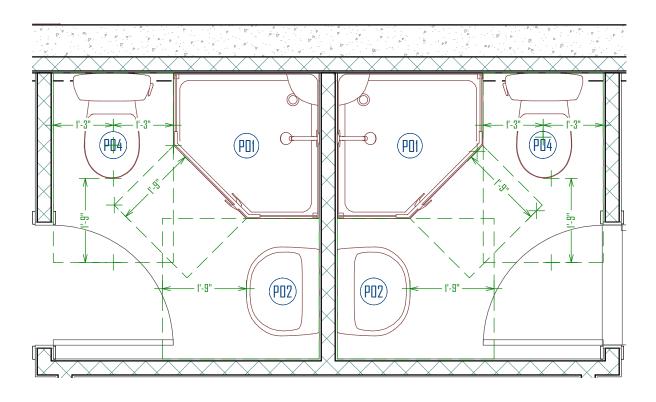


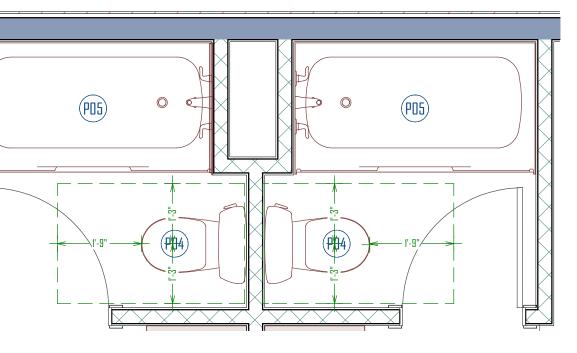


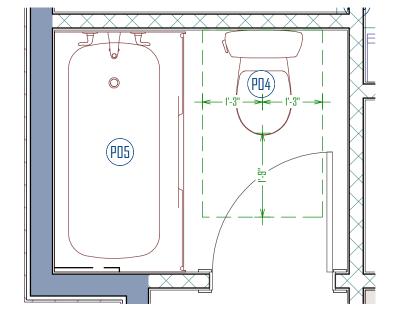



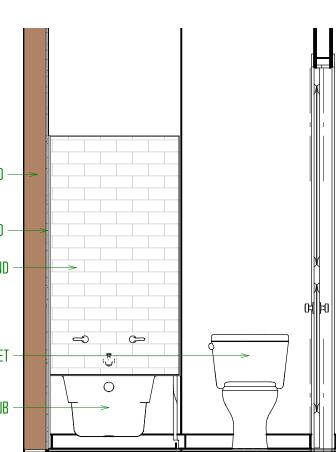

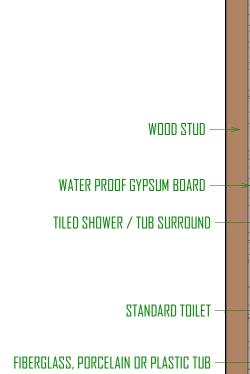

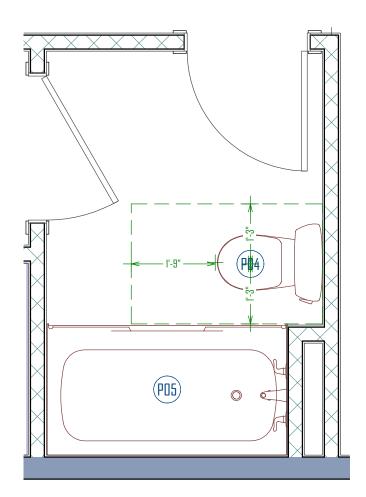

NOTES:

PLUMBING NOTES:

IRC P3103.2

1 .ALL WORK TO BE IN ACCORDANCE WITH THE 2015 IRC

2. WATER HEATERS SHALL BE STRAPPED AT THE UPPER ONE THIRD AND LOWER ONE THIRD, WITH THE LOWER STRAP NOT CLOSER THAN 4" ABOVE ANY CONTROLS TO WALLS WITHIN 12" 3. TOILETS SHALL BE 1.6 GALLON FLUSH TYPE. SHOWER HEADS SHALL BE

2.5 GPM TYPE. 4. PROVIDE PRESSURE REGULATOR AND SHUT OFF VALVE.

5. INTERIOR WASTE AND VENT LINES SHALL BE ABS.

6. FREEZLESS BACKFLOW PREVENTION HOSE BIBS WITH INTERIOR LOCATED ACCESSIBLE SHUT OFF VALVES REQUIRED.

7. PLUMBING VENTS SHALL BE AT LEAST 6' ABOVE OR 10' AWAY FROM ALL OUTSIDE AIR INTAKE OPENINGS.

8. NO SLIP JOINT PLUMBING CONNECTIONS ALLOWED IN CONCEALED AREAS.

9. INDIVIDUALLY INSULATE ALL PLUMBING, WATER, AND DRAIN LINES IN AREAS SUBJECT TO FREEZING. IO. INSTALL EXPANSION TANK FOR WATER HEATER. INSULATE HOT WATER


LINES IN UNFINISHED AREAS WITH 1/2" FOAM. HEAT / CHECK VALVES REQUIRED AT WATER HEATER INLET AND DUTLET. 11. PROVIDE ANTI SCALD VALVES ON ALL SHOWER AND TUB INSTALLATIONS.


12. BATHROOMS DIVIDED INTO SEPERATE WATER FIXTURE AREAS REQUIRE INDIVIUAL VENTING FOR EACH OF THE INDIVIDUAL AREAS 13. HOT WATER SUPPLIED TO SOAKER TUBS, BATHTUBS AND WHIRLPOOL TUBS SHALL BE LIMITED TO A MAX TEMPERATURE OF 120 DEGREES BY A WATER TEMPERATURE LIMITING DEVICE CONFORMING TO ASSE 1070 UNLESS PROTECTION IS PROVIDED BY A COMBINATION TUB/SHOWER VALVE IN CONFORMANCE WITH IPC 2708.3 & IRC 2713.3 14. ALL PLUMBING VENTS THROUGH THE ROOF TO BE MINIMUM 3" PIPE. -


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9

GREEN STREET BUILDING ADDITION	2324 SOUTH GREEN STREET,	FORREST DALE 27 & 28	SALT LAKE CITYUTAH
		וחח	
2/8		201	9
	PLUMBING DETAILS		
SHEET NUMBER:			



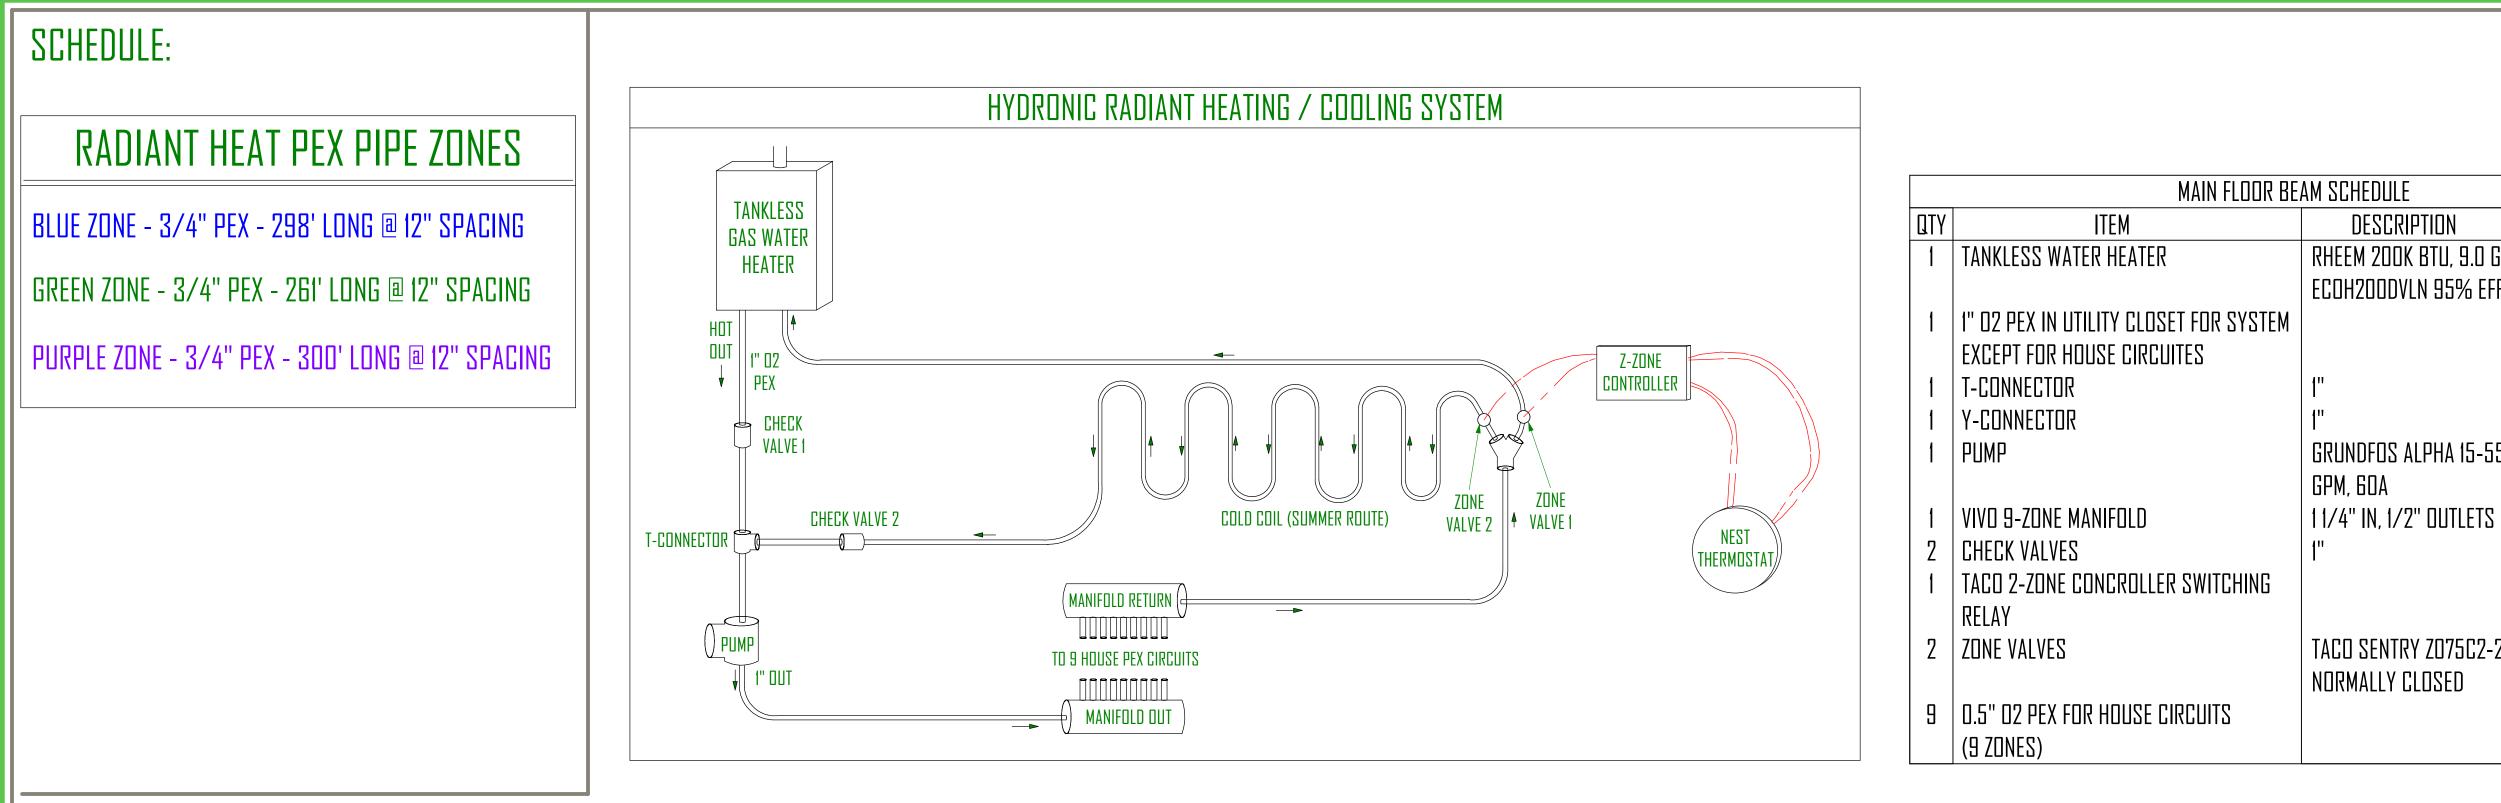

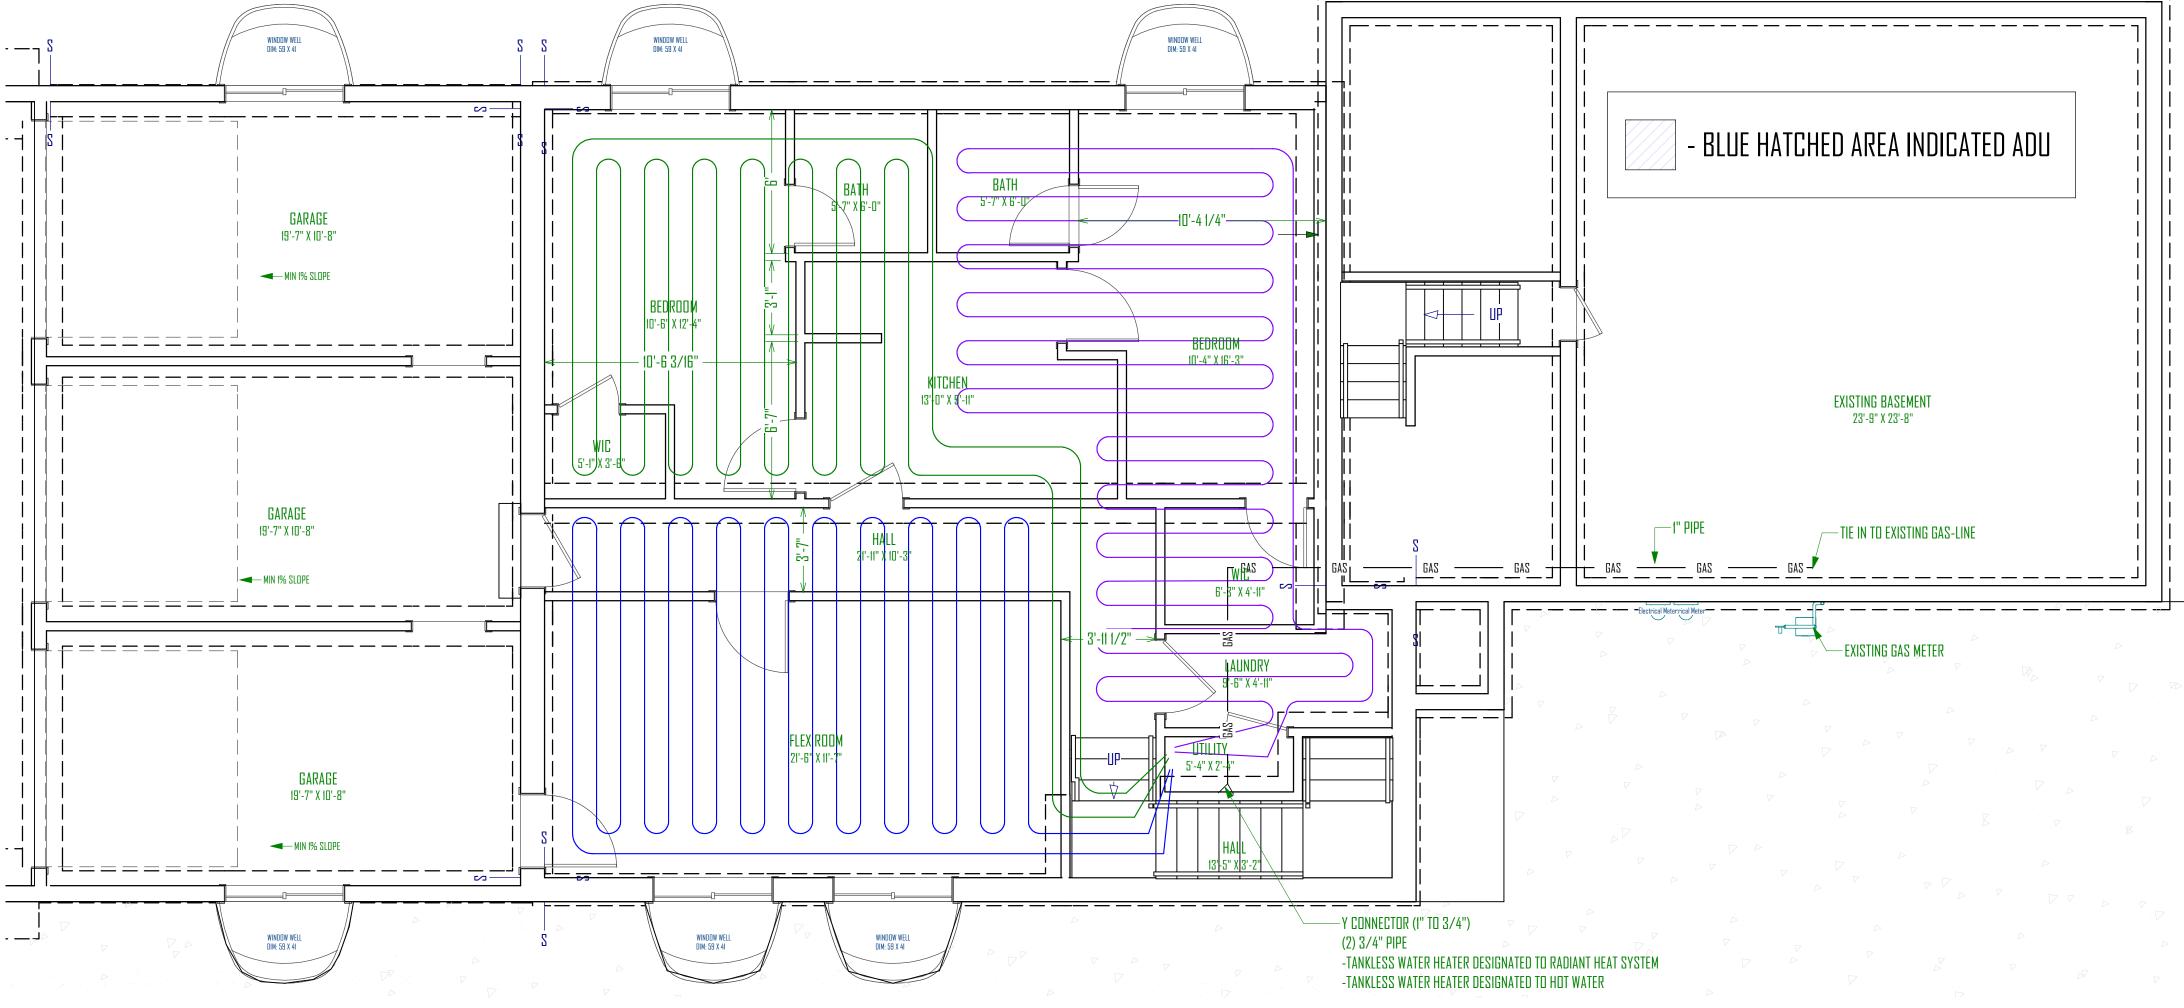

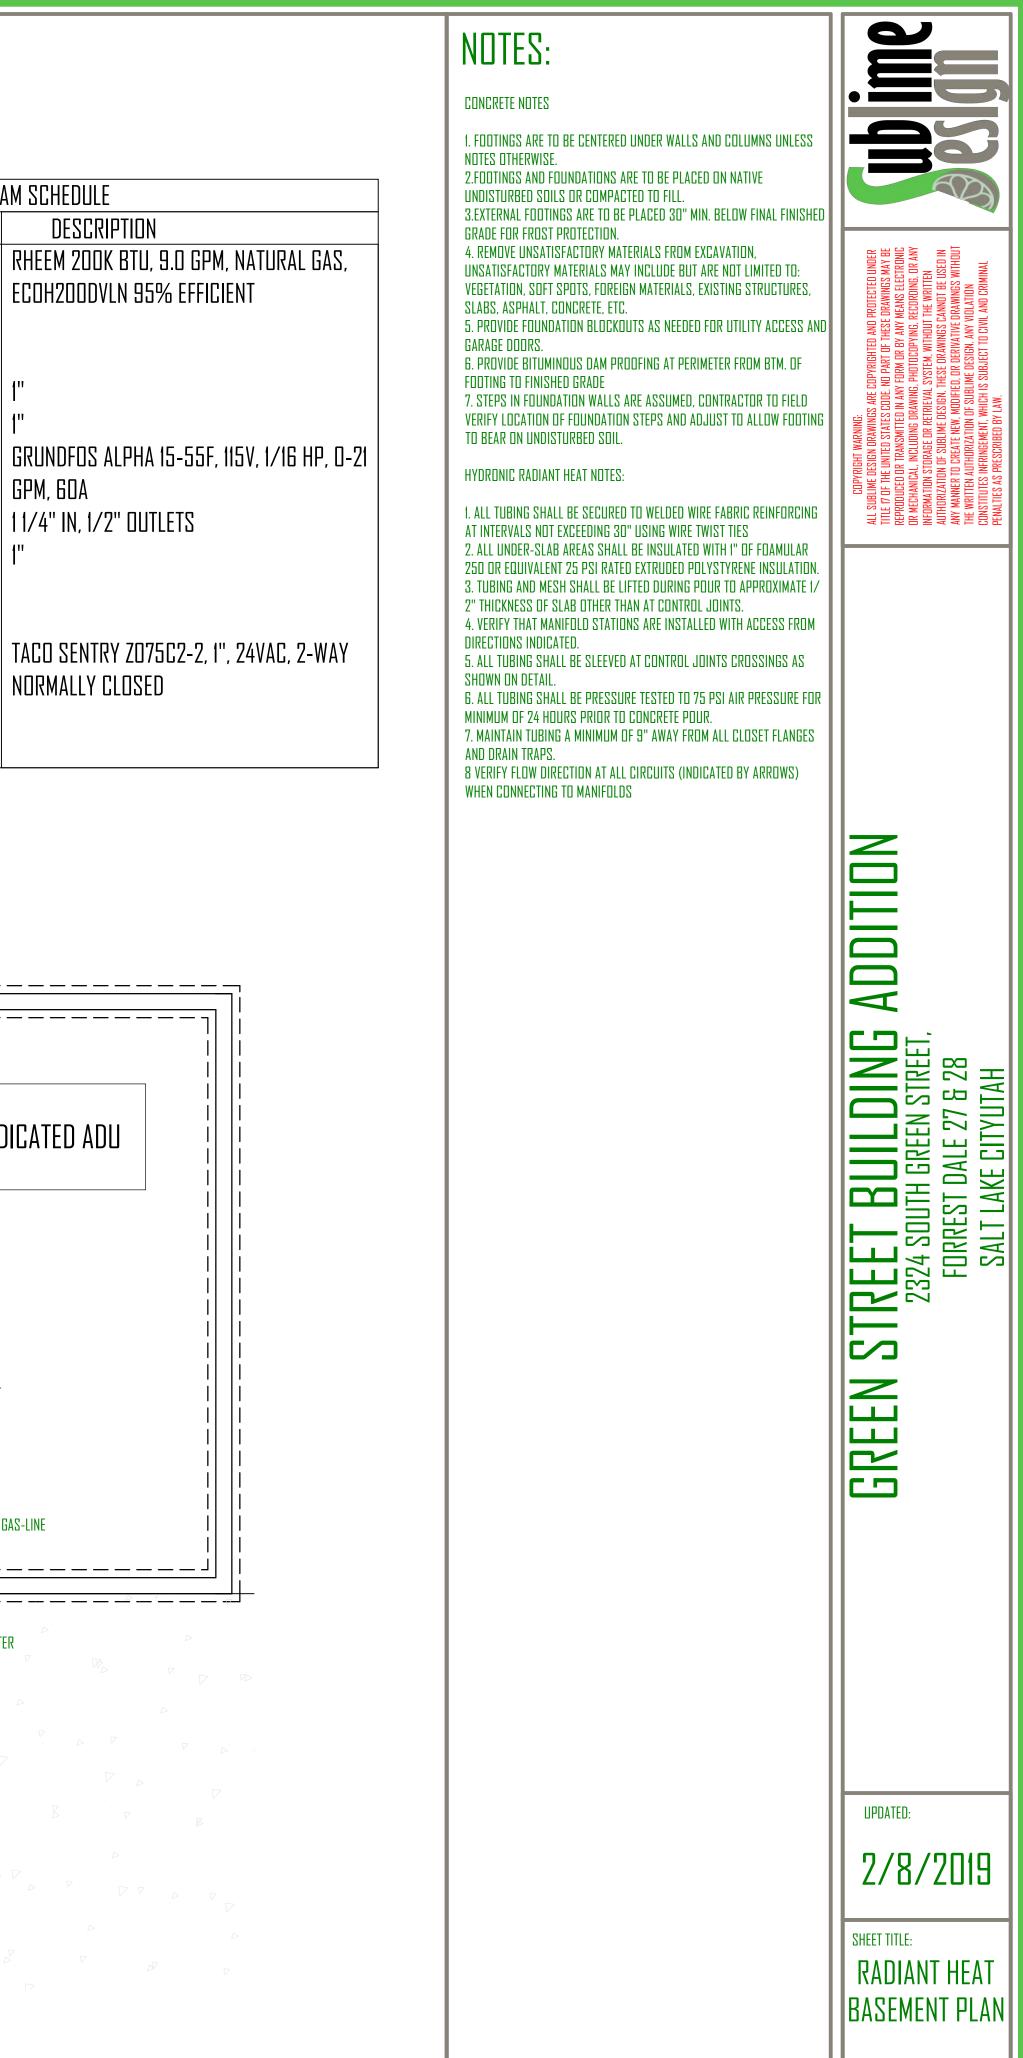SHEET NUMBER:

P₋7


TACO SENTRY Z075C2-2, 1", 24VAC, 2-WAY NORMALLY CLOSED


DESCRIPTION

SCHEDULE:

RADIANT HEAT PEX PIPE ZONES

RED ZONE - 1/2" PEX - 300' LONG @ 10" SPACING ORANGE ZONE - 1/2" PEX - 300' LONG @ 10" SPACING YELLOW ZONE - 1/2" PEX - 300' LONG @ 10" SPACING PURPLE ZONE - 1/2" PEX - 275" LONG @ 10" SPACING BLUE ZONE - 1/2" PEX - 300' LONG @ 10" SPACING

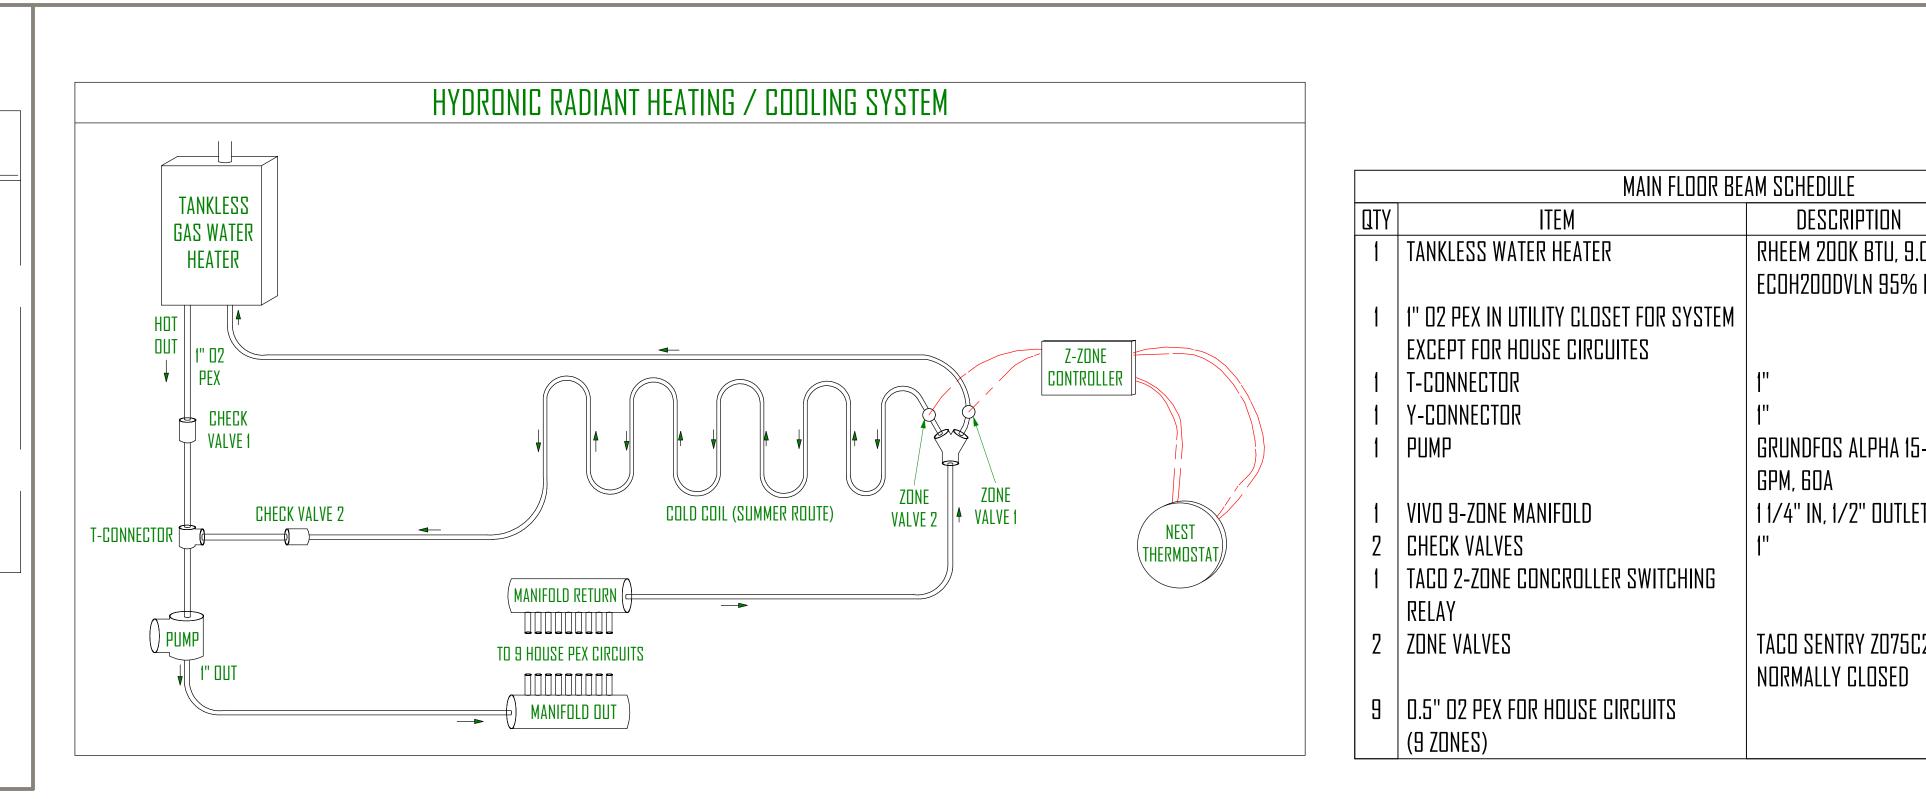

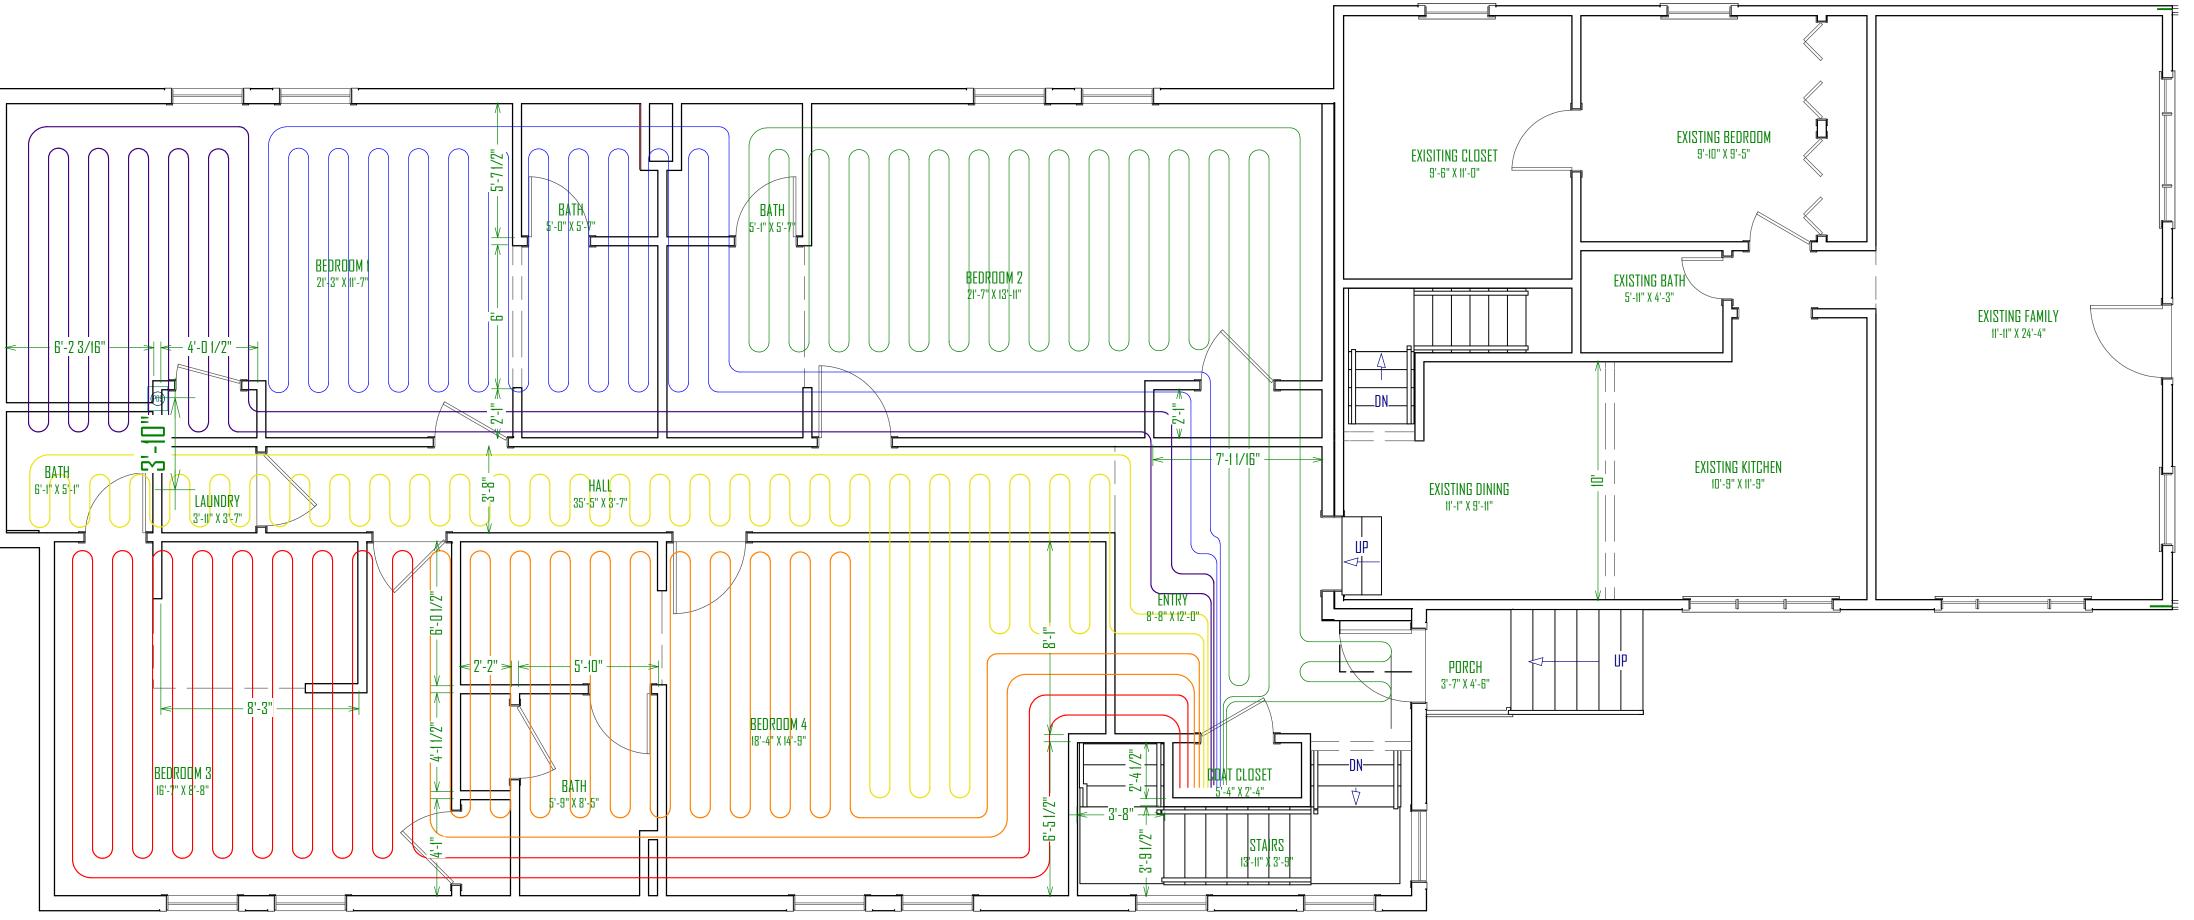

	NOTES:	JC
	CONCRETE NOTES	.56
O GPM, NATURAL GAS, EFFICIENT	 FODTINGS ARE TO BE CENTERED UNDER WALLS AND COLUMNS UNLESS NOTES OTHERWISE. FODTINGS AND FOUNDATIONS ARE TO BE PLACED ON NATIVE UNDISTURBED SOILS OR COMPACTED TO FILL. EXTERNAL FOOTINGS ARE TO BE PLACED 30" MIN. BELOW FINAL FINISHED GRADE FOR FROST PROTECTION. REMOVE UNSATISFACTORY MATERIALS FROM EXCAVATION, UNSATISFACTORY MATERIALS MAY INCLUDE BUT ARE NOT LIMITED TO: VEGETATION, SOFT SPOTS, FOREIGN MATERIALS, EXISTING STRUCTURES, SLABS, ASPHALT, CONCRETE, ETC. PROVIDE FOUNDATION BLOCKOUTS AS NEEDED FOR UTILITY ACCESS AND GARAGE DOORS. PROVIDE BITUMINOUS DAM PROOFING AT PERIMETER FROM BTM. OF FOOTING TO FINISHED GRADE STEPS IN FOUNDATION WALLS ARE ASSUMED, CONTRACTOR TO FIELD 	COPYRIGHT WARNING: COPYRIGHT WARNING: ALL SUBLIME DESIGN DRAWINGS ARE COPYRIGHTED AND PROTECTED UNDER TITLE <i>T</i> OF THE UNITED IN ANY FORM OR BY ANY MEANS ELECTRONIC REPRODUCED OR TRANSMITTED IN ANY FORM OR BY ANY MEANS ELECTRONIC OR MECHANICAL. INCLUDING DRAWINGS, PHOTOCOPYING, RECORDING, OR ANY MFORMATION STORAGE OR RETREVAL SYSTEM. WITHOUT THE WRITTEN ANTHORIZATION OF SUBLIME DESIGN. THESE DRAWINGS CANNOT BE USED IN ANY MANNER TO CREATE NEW. MODIFIED, OR DRENINGS CANNOT BE USED IN ANY MANNER TO CREATE NEW. MODIFIED, OR DRENINGS WITHOUT THE WRITTEN AUTHORIZATION OF SUBLIME DESIGN. ANY VIOLATION CONSTITUTES INFRINGEMENT, WHICH IS SUBJECT TO CIVIL AND CRIMINAL FILM ANTIFICS APRESCRIBED BY LAW.
-55F, 115V, 1⁄16 HP, 0-21	VERIFY LOCATION OF FOUNDATION STEPS AND ADJUST TO ALLOW FOOTING TO BEAR ON UNDISTURBED SOIL. HYDRONIC RADIANT HEAT NOTES:	COPYRIGHT WARNING: COPYRIGHT WARNING: ALL SUBLIME DESIGN DRAWINGS ARE TITLE 17 DF THE UNITED STATES CODI REPRODUCED DR TRANSMITTED IN AI DR MECHANICAL, INCLUDING DRAWIN DR MECHANICAL, INCLUDING DRAWIN DR MECHANICAL, INCLUDING DRAWIN AUTHORIZATION STORAGE DR REFRIEV AUTHORIZATION STORAGE DR REFRIEV ANN WANNER TD CREATE NEW, MODIS THE WRITTEN AUTHORIZATION OF SU SCINSTITUTES INFRINGEMENT, WHICH PENALTIES AS PRESCRIBED BY LAW.
TS	1. ALL TUBING SHALL BE SECURED TO WELDED WIRE FABRIC REINFORCING AT INTERVALS NOT EXCEEDING 30" USING WIRE TWIST TIES 2. ALL UNDER-SLAB AREAS SHALL BE INSULATED WITH 1" OF FOAMULAR 250 OR EQUIVALENT 25 PSI RATED EXTRUDED POLYSTYRENE INSULATION. 3. TUBING AND MESH SHALL BE LIFTED DURING POUR TO APPROXIMATE 1/	ALL SUB TITLE 17 REPROD DR MECH INFORMA AUTHORN AUY MACH THE WRAI FENALTIE PENALTIE
2-2, 1", 24VAC, 2-WAY	2" THICKNESS OF SLAB OTHER THAN AT CONTROL JOINTS. 4. VERIFY THAT MANIFOLD STATIONS ARE INSTALLED WITH ACCESS FROM DIRECTIONS INDICATED. 5. ALL TUBING SHALL BE SLEEVED AT CONTROL JOINTS CROSSINGS AS SHOWN ON DETAIL. 6. ALL TUBING SHALL BE PRESSURE TESTED TO 75 PSI AIR PRESSURE FOR MINIMUM OF 24 HOURS PRIOR TO CONCRETE POUR. 7. MAINTAIN TUBING A MINIMUM OF 9" AWAY FROM ALL CLOSET FLANGES AND DRAIN TRAPS. 8 VERIFY FLOW DIRECTION AT ALL CIRCUITS (INDICATED BY ARROWS) WHEN CONNECTING TO MANIFOLDS	
		GREEN STREET BUILDING ADDITION 2324 SDUTH GREEN STREET, FORREST DALE 27 & 28 SALT LAKE CITYUTAH SALT LAKE CITYUTAH

UPDATED:

SHEET TITLE:

2/8/2019

RADIANT HEAT


MAIN FLOOR

PLAN

P-3

SHEET NUMBER:

SCHE	SCHEDULE:			
		BASEMENT ELECTRICA	AL SCHEDULE	
NUMBER	QTY		COMMENTS	
EDI	13	GFCI		
EO2	15	DUPLEX		
EO3	4	LUTRON MAESTRO DIMMER- OCCUPANCY-SWITCH		
E05	1	CO DETECTOR		
E06	2	ELECTRICAL PANEL		
E07	2	EXHAUST FAN		
E08	2	EXTERIOR WALL LIGHT		
E09	1	220V		
E10	3	THREE WAY		
E11	2	VANITY LIGHT		
E12	1	GFCI WP		
E13	9	KEY LIGHT		
E14	3	DUPLEX, CEILING MOUNTED		
E15	15	SINGLE POLE		
E16	29	CAN LIGHT		
E17	1	TDE KICK LIGHTING		
E18	1	OCCUPANCY SENSOR		
E19	4	UNDER CABINET LIGHTING		

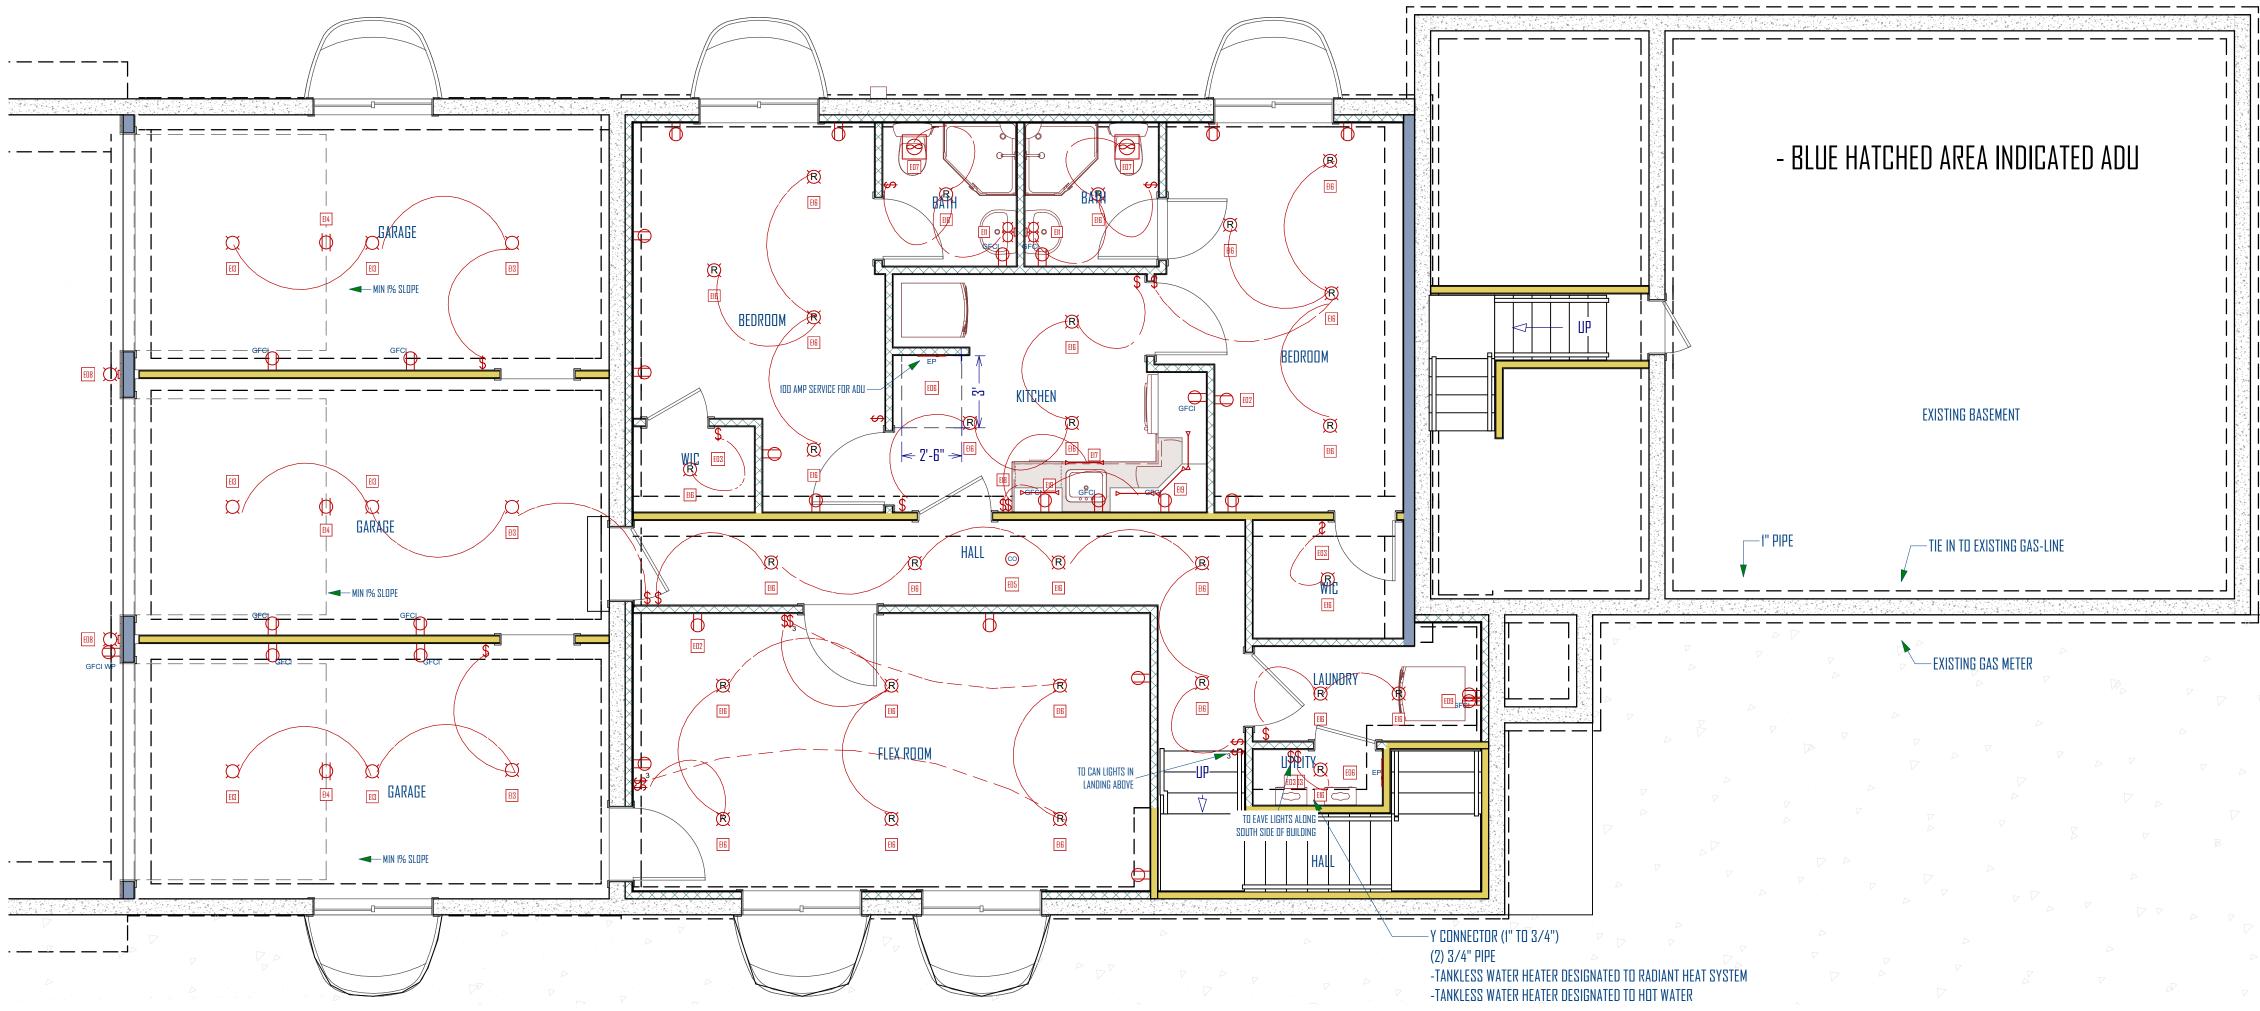

BASEMENT ELECTRICAL PLAN SCALE: 1/4"=1'-0"

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METER	

NOTES:

ELECTRICAL NOTES:

1. PERMANENTLY WIRED SMOKE DETECTORS ARE REQUIRED AND MUST BE INSTALLED IN EACH SLEEPING ROOM AND AT A POINT CENTRALLY LOCATED IN THE CORIDOOR OR AREA GIVING ACCESS TO THE EACH SEPARATE AREA. WHEN THE DWELLING UNIT HAS MORE THAN ONE STORY OR BASEMENT OS SPLIT LEVEL INTO TWO OR MORE LEVELS, THE DETECTOR SHALL BE INSTALLED ON THE UPPER LEVEL, EXCEPT THAT WHEN A LOWER LEVEL CONTAINS A SLEEPING AREA, A DETECTOR SHALL BE INSTALLED ON EACH LEVEL . WHEN SLEEPING ROOMS ARE ON AN UPPER LEVEL THE DETECTOR SHALL BE PLACED ON THE CEILING OF THE UPPER LEVEL IN CLOSE PROXIMITY OF THE STAIRWAY. IN DWELLING UNITS WHERE THE CEILING HEIGHT OF A ROOM OPEN TO THE HALLWAY SERVING THE BEDROOMS EXCEEDS THAT OF THE HALLWAY BY 24" OR MORE; SMOKE DETECTORS SHALL BE INSTALLED IN THE HALLWAY AND ADJACENT ROOM. DETECTORS SHALL SOUND AN ALARM AUDIBLE IN ALL SLEEPING AREAS OF THE DWELLING UNIT IN WHICH THEY ARE LOCATED. DETECTORS MUST HAVE A BATTERY BACK UP AND MUST EMIT A SIGNAL WHEN THE BATTERIES ARE LOW. DETECTORS MUST BE WIRED IN SERIES.

2. BATHROOM RECEPTACLE OUTLETS SHALL BE SUPPLIED BY DEDICATED 20 AMP BRANCH CIRCUIT WITH NO OTHER OUTLETS. 3. INCANDESCENT CLOSET LIGHTING SHALL BE 18 MINIMUM FROM

COMBUSTIBLES MEASURE HORIZONTALLY. 6" HORIZONTALLY IS PERMITTED FOR FLUSH FIXTURES AND FLORESCENT FIXTURES. 4. GROUND FAULT CIRCUIT PROTECTION REQUIRED FOR ALL 110V, SINGLE

PHASE 15 AND 20 AMP RECEPTICALS IN BATHROOMS, GARAGES AND OUTDOORS WHERE THERE IS A DIRECT GRADE LEVEL ACCESS TO DWELLINGS AND POWER POLES. GFIC OLSO REQUIRED FOR ALL COUNTER TOP LEVEL KITCHEN RECEPTICALS. GARAGE OUTLETS MUST BE A MIN OF 18" ABOVE FLOOR.


5. ALL INCANDESCENT LIGHTING FIXTURES RECESSED INTO INSULATED AREAS SHALL BE APPROVED FOR ZERO CLEARANCE INSULATION COVER (I.C.) PER THE 2015 MANDATORY ENERGY REQURIEMENTS. 6. CONDUIT FOR METER BASED SERVICE ENTRANCE SHALL BE ANCHORED TO FOUNDATION WITH UNISTRUT AND CONDUIT CLAMPS (POWDER ACTUATED FASTENERS ARE NOT PERMITTED)

7. OUTLETS SHALL BE SPACE ACCORDING TO PREVAILING CODES AS A MINIMUM REQUIREMENT. ACTUAL OUTLET LOCATION MAY VARY FROM PLAN. 8. METALLIC WATER SERVICE OR A CONCRETE ENCASED ELECTRODE (UFER GROUND) AVAILABLE FOR USE AS A GROUNDING ELECTRODE FOR THE HOUSE WHICH MEETS THE REQUIREMENTS OF THE 2015 IRC SHALL BE REQUIRED. UFERGROUND SHALL BE REQUIRED WHEN SOIL CONDITIONS AND GROUND WATER CONTENT DO NOT PROVIDE ADEQUATE GROUNDING RESISTANCE (VERIFY UFER REQURIEMENT WITH LOCAL CODES AND ORDINANCES.

9. PLASTIC ELECTRICAL BOXES IN GARAGE FIRE WALLS TO BE 2HR LISTED. 10. ALL BEDROOM CIRCUITS SHALL BE ARC FAULT PROTECTED (AFCI) 11. INCLUDE ONE CARBON MONOXIDE DETECTOR PER LEVEL WIRE IN SERIES WITH SMOKE ALARMS AND PROVIDE A BATTERY BACK-UP 12. LOCATE EXTERIOR 110V SERVICE OUTLET WITHIN 25' OF AC UNIT.

Jelon Second		
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GREEN STREET BUILDING ADDITION 2324 South Green Street, Forrest dale 27 & 28 Salt lake cityutah		
updated: 2/8/2019		
SHEET TITLE: BASEMENT ELECTRICAL PLAN SHEET NUMBER:		

SCHE	SCHEDULE:			
		MAIN FLOOR ELECTRIC	AL SCHEDULE	
NUMBER	QTY	DESCRIPTION	COMMENTS	
EDI	16	GFCI		
ED2	27			
EO3	24	SINGLE POLE		
EO4	1	3-WAY SWITCH		
E05	4	EXHAUST FAN		
E06	1	EXTERIOR WALL LIGHT		
EO8	60	CAN LIGHT		
E09	3	OCCUPANCY SENSOR		
E10	1	220V		
E11	4	TDE KICK LIGHTING		

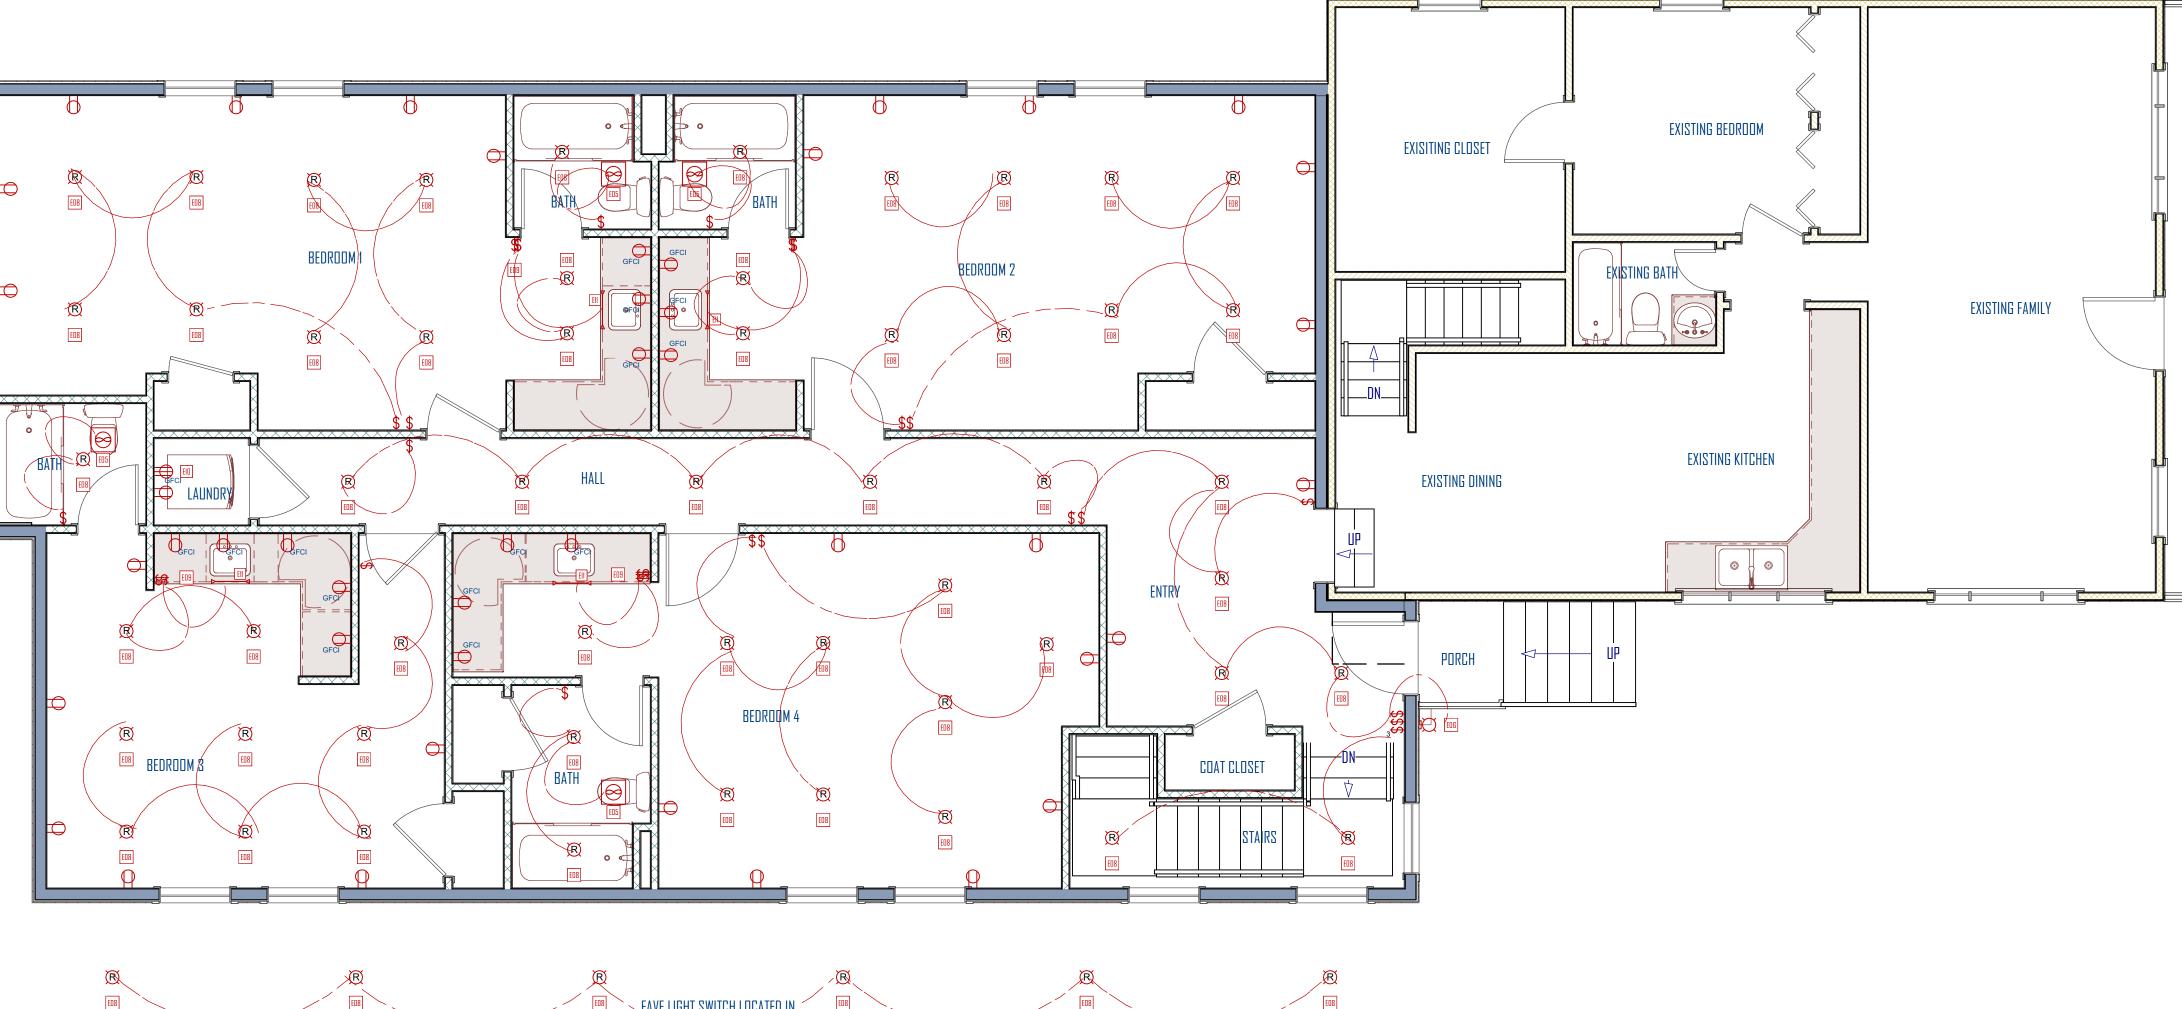

MAIN FLOOR ELECTRICAL PLAN SCALE: 1/4"=1'-0"

EAVE LIGHT SWITCH LOCATED IN MECH. ROOM IN BASEMENT



ELECTRICAL NOTES:

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GREEN STREET BUILDING ADDITION 2324 South Green Street, Forrest dale 27 & 28 Salt lake cityutah
updated: 2/8/2019
SHEET TITLE: MAIN FLOOR ELECTRICAL PLAN
SHEET NUMBER: E-Z